9.1 NOS. 177 - 179 (LOT: 7; S/P: 35040) CARR PLACE, LEEDERVILLE: PROPOSED NINE GROUPED DWELLINGS

Ward:	South
Attachments:	 Consultation and Location Map Superseded Plans from First Round of Advertising Development Plans 3D Perspectives Urban Design Study Environmentally Sustainable Design Report & Template Design Review Panel Meeting Minutes - 19 May 2021 Summary of Submissions - Administration's Response Determination Advice Notes
	 Development Plans 3D Perspectives Urban Design Study Environmentally Sustainable Design Report & Template Design Review Panel Meeting Minutes - 19 May 2021 Summary of Submissions - Administration's Response

RECOMMENDATION:

That Council, in accordance with the provisions of the City of Vincent Local Planning Scheme No. 2 and the Metropolitan Region Scheme, APPROVES the development application for Nine Grouped Dwellings at Nos. 177 - 179 (Lot: 7; S/P: 35040) Carr Place, Leederville in accordance with the plans in Attachment 3, subject to the following conditions, with the associated determination advice notes in Attachment 9:

1. Development Plans

This approval is for Nine Grouped Dwellings as shown on the approved plans dated 20 July 2021. No other development forms part of this approval;

2. Boundary Walls

The surface finish of boundary walls facing an adjoining property shall be of a good and clean condition, prior to the occupation or use of the development, and thereafter maintained, to the satisfaction of the City. The finish of boundary walls is to be fully rendered or face brick, or material as otherwise approved, to the satisfaction of the City;

3. External Fixtures

All external fixtures, such as television antennas (of a non-standard type), radio and other antennaes, satellite dishes, solar panels, external hot water heaters, air conditioners, and the like, shall not be visible from the street(s), are designed integrally with the building, and be located so as not to be visually obtrusive to the satisfaction of the City;

4. Visual Privacy

Prior to occupancy or use of the development, all privacy screening shown on the approved plans shall be installed and shall be visually impermeable and is to comply in all respects with the requirements of Clause 5.4.1 of the Residential Design Codes (Visual Privacy) deemed to comply provisions, to the satisfaction of the City;

5. Colours and Materials

- 5.1 Prior to first occupation or use of the development, the colours, materials and finishes of the development shall be in accordance with the details and annotations as indicated on the approved plans which forms part of this approval, and thereafter maintained, to the satisfaction of the City; and
- 5.2 The metre box is to be painted the same colour as the wall it is attached so as to not be visually obtrusive, to the satisfaction of the City;

6. Landscaping

All landscaping works shall be undertaken in accordance with the approved plans dated 20 July 2021, prior to the occupancy or use of the development and maintained thereafter to the satisfaction of the City at the expense of the owners/occupiers;

7. Stormwater

Stormwater from all roofed and paved areas shall be collected and contained on site. Stormwater must not affect or be allowed to flow onto or into any other property or road reserve;

8. Sight Lines

No walls, letterboxes or fences above 0.75 metres in height to be constructed within 1.5 metre of where:

- Walls, letterboxes or fences adjoin vehicle access points to the site; or
- A driveway meets a public street; or
- Two streets intersect;

Unless otherwise approved by the City of Vincent;

- 9. Car Parking and Access
 - 9.1 The layout and dimensions of all driveway(s) and parking area(s) shall be in accordance with AS2890.1;
 - 9.2 All driveways, car parking and manoeuvring area(s) which form part of this approval shall be sealed, drained, paved and line marked in accordance with the approved plans prior to the first occupation of the development and maintained thereafter by the owner/occupier to the satisfaction of the City;
 - 9.3 Prior to the occupation or use of the development, two visitor parking bays shall be permanently marked, maintained and legally accessible at all times for use exclusively by visitors to the property, be clearly visible or suitably sign posted from the street or communal driveway and be located, together with the reversing area, in front of any security gates or barrier for the development unless otherwise approved by the City; and
 - 9.4 No good or materials being stored, either temporarily or permanently, in the parking or landscape areas or within the access driveways. All goods and materials are to be stored within the buildings or storage yards, where provided;
- 10. Construction Management Plan

A Construction Management Plan shall be lodged with and approved by the City prior to issue of a building permit. This plan is to detail how construction will be managed to minimise disruption in the area and shall include:

- Storage of materials and equipment on site;
- Parking arrangements for contractors and sub-contractors;
- The impact on traffic movement;
- Notification to affected land owners; and
- Construction times.

The approved Construction Management Plan shall be complied with for the duration of the construction of the development; and

- 11. Noise Attenuation Requirements
 - 11.1 Prior to the issue of a building permit a detailed Noise Management Plan must be submitted to and approved by the City which demonstrates that the development has been designed to meet the relevant requirements of State Planning Policy 5.4 'Road

and Rail Transport Noise and Freight Considerations in Land Use Planning' (SPP5.4). The report must be prepared by a suitably qualified and competent person in accordance with the SPP5.4; and

11.2 Prior to occupation or use of the development, the development shall incorporate all noise mitigation measures as outlined in the noise management plan or quiet house design package, to the satisfaction of the City.

PURPOSE OF REPORT:

To consider an application for development approval for nine grouped dwellings at Nos. 177-179 Carr Place, Leederville (the subject site).

PROPOSAL:

The application proposes the construction of nine additional grouped dwellings on the southern portion of the subject site. The dwellings are proposed to be two and three storeys in height. Each dwelling is proposed to have a double garage accessed from common property, with two visitor parking bays provided. Vehicle access to the subject site is provided from Bold Court.

There are no modifications proposed to the existing grouped dwellings on the northern portion of the subject site.

The development plans the subject of the application are included as Attachment 3.

BACKGROUND:	
Landowner:	Collins Property Group (WA) Pty Ltd
Applicant:	Jason Collins
Date of Application:	9 April 2021
Zoning:	MRS: Urban
	LPS2: Regional Centre R Code: Not applicable
Built Form Area:	Town Centre
Existing Land Use:	Six Existing Grouped Dwellings and Vacant Land
Proposed Use Class:	Grouped Dwellings
Lot Area:	Total area: 2,732m ²
	Subject area: 1,354m²
Right of Way (ROW):	Not applicable
Heritage List:	Not applicable

BAG

Site Context

The subject site is bound by Carr Place to the north, single residential development to the east, and commercial developments to the south and west. A location plan is included as Attachment 1.

The subject site has a total area of 2,732 square metres and currently consists of six grouped dwellings on the northern portion of the subject site. The proposed development the subject of this application is situated on the southern portion of the subject site. The development site has an area of 1,354 square metres and consists of a number of outbuilding structures. These are proposed to be removed as part of the development.

The subject site is landlocked by existing development with vehicle access provided from Bold Court. The surrounding development context consists of the following:

- To the north the existing six grouped dwellings on the subject site are two storeys in height, with • pedestrian and vehicle access provided from Carr Place. The existing dwellings are separated from the proposed development by an uncovered parking area which provides for six parking bays;
- To the south the proposed development abuts an uncovered parking area of a two storey office development at No. 620 Newcastle Street. The parking area provides for 11 parking bays;
- To the west the proposed development abuts No. 622 Newcastle Street and No. 181 Carr Place. No. 622 Newcastle Street consists of a single storey commercial development which accommodates six

tenancies. These tenancies currently operate as various uses including office, car panel beating and painting, and a brewery. A vehicle access leg on No. 622 Newcastle Street adjoins the subject site, and provides access to a central covered parking area. No. 181 Carr Place consists of a two-storey office development accommodating six tenancies. Five uncovered parking bays are located at the rear of this development abutting the subject site;

- To the east development consists of residential development which varies between two and three storeys in height. The developments along the northern portion of Bold Court have their primary frontage to Carr Place. This includes a three storey apartment building on the corner of Carr Place and Bold Court which is accessed from Bold Court. Bold Court is the primary frontage for the developments located along the southern portion of this road. The Bold Court streetscape can be characterised as being dominated by boundary fencing and outbuildings on its northern side, and vehicle access points to double garages associated with two storey dwellings on its southern side; and
- Abutting the north-east portion of the development site is a garage that is built up to the western lot boundary at the rear of No. 175 Carr Place. Immediately to the south-east of the development site is a two storey dwelling at No. 11 Bold Court. The outdoor living area of this dwelling is located to the southern side of the property.

Planning Framework

The subject site and adjoining properties are zoned Regional Centre under the City's Local Planning Scheme No. 2 (LPS2). The subject site does not have a density coding under LPS2. As per the Residential Design Codes Volume 1 (R Codes), the proposed development is subject to the R80 development standards given it is located in an activity centre.

The subject site and adjoining properties are within the Town Centre built form area under the Built Form Policy, and also falls within Precinct 8 – Network City of the Leederville Town Centre Masterplan and Built Form Guidelines (Leederville Masterplan). The Leederville Masterplan permits a building height of five storeys.

Leederville is identified as being a Secondary Centre in accordance with the Western Australian Planning Commission's (WAPC) State Planning Policy 4.2 – Activity Centres for Perth and Peel (SPP 4.2). In accordance with SPP 4.2, the City is currently preparing the Leederville Precinct Structure Plan (LPSP) which will guide future development within the locality. The draft PSP is intended to be presented to an upcoming Council meeting for endorsement following advertising.

Subdivision Approval

A subdivision application for the subject site was lodged with the WAPC in March 2021. This application seeks to separate the proposed development site from the existing grouped dwelling development on the northern portion of the subject site.

The subdivision application was approved by the WAPC on 30 June 2021. The two new lots have yet to be created.

A built strata subdivision application for the lot was lodged and approved by the WAPC on 30 June 2021. The strata application sought to modify the existing boundary of existing grouped dwellings at Nos. 177-179 Carr Place.

DETAILS:

Summary Assessment

The table below summarises the planning assessment of the proposal against the provisions of LPS2, the Built Form Policy, the Leederville Masterplan, and the State Government's Residential Design Codes. The Leederville Masterplan prevails over the Built Form Policy where there is any inconsistency, as specified in the Built Form Policy.

In each instance where the proposal requires the discretion of Council, the relevant planning element is discussed in the Detailed Assessment section following from this table.

Planning Element	Use Permissibility/ Deemed-to-Comply	Requires the Discretion of Council
Land Use		\checkmark
Street Setback	\checkmark	
Front Fence	\checkmark	
Building Setbacks/Boundary Wall		✓
Building Height/Storeys	✓	
Open Space	✓	
Outdoor Living Areas	✓	
Landscaping (R Codes)		✓
Privacy	✓	
Parking & Access		✓
Solar Access	✓	
Site Works/Retaining Walls	✓	
Essential Facilities	✓	
External Fixtures	✓	
Surveillance	✓	

Detailed Assessment

The deemed-to-comply assessment of the element that requires the discretion of Council is as follows:

Land Use					
Deemed-to-Comply Standard	Proposal				
LPS 2 – Clause 18					
'P' use	Grouped Dwellings is a 'D' use in the Regional Centre zone				
Lot Bound	ary Setback				
Deemed-to-Comply Standard	Proposal				
R Codes Clause 5.1.3 – Lot Boundary Setback					
<u>First Floor</u> Unit A: Terrace – Living: 2.8 metres Unit D: Kitchen – Living: 1.5 metres	<u>First Floor</u> Unit A: Terrace – Living: 1.6 metres Unit D: Kitchen – Living: 1.0 metre				
<u>Second Floor</u> Unit D: Study: 1.4 metres	<u>Second Floor</u> Unit D: Study: 1.1 metres				
Landscaping					
Deemed-to-Comply Standard	Proposal				
R Codes Clause 5.3.2 – Landscaping					
One tree within a 2 metre by 2 metre planting area per dwelling	Unit A: 1.0 metre by 2.0 metre tree planting area Unit B: 1.2 metre by 1.8 metre tree planting area Unit C: 1.8 metre by 2.0 metre tree planting area				
Parking a	nd Access				
Deemed-to-Comply Standard	Proposal				
R Codes Clause 5.3.3 – Parking					
Three on-site visitor parking bays required.	Two on-site visitor parking bays proposed				

The above element of the proposal does not meet the specified deemed-to-comply standards and is discussed in the Comments section below.

CONSULTATION/ADVERTISING:

Community consultation was undertaken in accordance with the *Planning and Development (Local Planning Scheme) Regulations 2015* for a period of 14 days commencing on 3 June 2021 and concluding on

17 June 2021. Community consultation was undertaken by means of written notification being sent to surrounding landowners within a 75 metre radius, as shown in **Attachment 1** and a notice on the City's website in accordance with the City's Policy 4.1.5 – Community Consultation.

At the conclusion of the community consultation period, 11 submissions were received. Two submissions were in support and nine objected to the proposal.

Seven of these objectors provided their opposition to the proposal detailed in one document. Administration contacted each of these objectors and confirmed their comments of objection as contained in the document.

Concerns raised during the community consultation period are summarised as follows:

- Increased traffic to Bold Court as a result of vehicle access not being provided from Carr Place;
- Vehicle access movements and management of traffic during the construction period; and
- Location of the bin store area.

A summary of the submissions received along with Administration's responses are provided in Attachment 8.

The applicant elected not to provide a response to community consultation submissions.

Amendments to the R Codes Volume 1 were gazetted on 2 July 2021, which resulted in a new departure to the deemed-to-comply requirement for the number of on-site visitor bays. Lot boundary setback and landscaping departures to the deemed-to-comply standards of the R Codes previously also had not been advertised.

Administration undertook community consultation for a further seven days commencing on 16 July 2021 and concluding on 23 July 2021 in relation to these aspects of the proposal. This consultation was undertaken by means of written notification being sent to directly abutting properties and previous submitters. At the conclusion of this community consultation period no additional submissions were received.

Administration received written correspondence from a previous objector after Council's 10 August 2021 Briefing Session advising that they now support the proposal. The submitter's initial objection raised concern with the box guttering for Units H & I and the common bin store area. The submitter now supports the proposed development as amendments to the proposal during the course of the assessment process have addressed their previous concerns. The submitter also advised that they would strongly object to any higher density and additional building height of a four to five storey scale in this location.

Design Review Panel (DRP):

Referred to DRP: Yes

Administration referred the development plans as originally submitted to the DRP. These plans are included in **Attachment 2**. The minutes from the Design Review Panel meeting are included as **Attachment 7**. A summary of the application's progress through the DRP and referral to DRP member is summarised in the table below.

	Design Review Progress Report				
Design q	uality evaluation				
	Supported				
	Pending further attention – refer to	detailed comments	s provided		
	Not supported				
	Insufficient information for design of	quality evaluation tr	affic signal colours to	be attributed	
	DRP 1DRP Member'sDRP Member's19 May 2021CommentsComments12 July 202122 July 2021				
Principle	1 - Context and character				

Principle 2 - Landscape quality		
Principle 3 - Built form and scale		
Principle 4 - Functionality and build quality		
Principle 5 – Sustainability		
Principle 6 – Amenity		
Principle 7 – Legibility		
Principle 8 – Safety		
Principle 9 – Community		
Principle 10 - Aesthetics		

The DRP was not supportive of the initial proposal and raised the following concerns:

- Vehicle access dominates the access and streetscape interface of the development, which provides for double garages for each dwelling;
- Upper floor terraces of Units B and C would have direct interface to those of Unit D and Unit E;
- Landscaping areas are undersized and planting areas do not provide adequate urban greening experience at the ground level;
- Potential underdevelopment of the site given the Town Centre and central Leederville location;
- Lack of openings to the northern aspect to capitalise on natural sunlight;
- Openings and habitable spaces do not offer relief from sunlight; and
- Materiality and application of colours of the development require refinement.

To address the comments, the DRP made a number of suggestions to improve the built form outcome of the development and its interaction with Bold Court and neighbouring development as follows:

- Increase the location and dimensions of landscaping opportunities across the site to allow for species to reach maturity;
- Provide for a greater emphasis on the pedestrian scale and experience;
- Introduce awning and/or window details to dwellings;
- Provide for additional openings to the ground and upper floors;
- Consider visual privacy screening mechanisms to the terraces which address the common property area; and
- Consider the use of contrasting colours and materials of the dwellings.

The applicant submitted amended plans incorporating the DRP feedback and recommendations, which are included as **Attachment 3**. These amended plans were re-advertised to previous submitters. A summary of the key changes of the amended plans is included below.

- Larger window provided to the bedroom on the ground floor of Unit I;
- Contrasting paving to delineate between the vehicle and pedestrian access;
- Cantilevered arbour beams for the start of the pedestrian walkway;
- Awnings added to the living rooms of Units B H;
- Privacy screens added to the balcony of Units B and C;
- Garden beds in driveways of Units D G increased from 1.0 metre to 2.0 metre depth; and
- Communal bench seat added to the Bold Court entry and driveway.

The revised development plans were referred to a DRP member seeking comments on the acceptability of the changes and whether the proposal would provide a positive contribution to the Leederville locality. The revised plans addressed recommendations to the landscaping, pedestrian experience and privacy concerns raised by the DRP.

The DRP member advised that:

- The overall site planning and built form outcome of the proposal remained identical and had not been amended through the application process;
- Although the development provides additional housing to the locality, it still remains as an underdevelopment within the Town Centre;

- The development is car-focused and presents poorly to the streetscape with a garage and bin store to the public realm; and
- Notwithstanding this the development is economical and has an appropriate scale and massing.

The final set of development plans to be determined are included as **Attachment 3**.

LEGAL/POLICY:

- Planning and Development Act 2005;
- Planning and Development (Local Planning Schemes) Regulations 2015;
- City of Vincent Local Planning Scheme No. 2;
- State Planning Policy 5.4 Road and Rail Transport Noise and Freight Considerations in Land Use Planning;
- State Planning Policy 7.3 Residential Design Codes Volume 1;
- Policy No. 4.1.5 Community Consultation;
- Policy No. 7.1.1 Built Form Policy; and
- Leederville Town Centre Masterplan and Built Form Guidelines.

Planning and Development Act 2005

In accordance with Schedule 2, Clause 76(2) of the *Planning and Development (Local Planning Schemes) Regulations 2015* and Part 14 of the *Planning and Development Act 2005*, the applicant would have the right to apply to the State Administrative Tribunal for a review of Council's determination.

State Planning Policy 7.3 – Residential Design Codes Volume 1

Amendments to the R Codes Volume 1 were gazetted and took effect on 2 July 2021.

Amendments to the R Codes resulted in new departures to the deemed-to-comply requirements for the number of on-site visitor bays and the landscaping provisions.

The plans as originally lodged included in **Attachment 2** were submitted on 29 March 2021, and were assessed against and advertised based on the provisions of the previous version of the R Codes.

Amended plans included in **Attachment 3** were received on 1 July 2021 prior to the gazettal date of the R Codes amendments. These amended plans have been assessed against and re-advertised based on the current version of the R Codes, as it applies at the time of determination of the subject application by Council.

Amendment 3 to Policy No. 7.1.1 – Built Form

Council resolved to adopt Amendment 3 to the Built Form Policy at its Ordinary Meeting on 22 June 2021. The purpose of the amendment was to address inconsistencies between the Built Form Policy and the R Codes that would result from the amendments to the R Codes that were gazetted on 2 July 2021.

Draft Leederville Precinct Structure Plan

Consultation on the draft LPSP closed on 5 July 2021. The draft LPSP is intended to be presented to an upcoming Council meeting for endorsement following advertising. Once endorsed, the LPSP would still require approval from the WAPC.

The draft LPSP identifies the subject site as being zoned Residential R80. The subject site is also identified as being within the Urban Frame Type B sub-precinct, with a building height of eight storeys permitted which could increase to 10 storeys if the bonus criteria are satisfied.

A future laneway/pedestrian link has been indicated through the subject site and No. 620 Newcastle Street which adjoins the subject site to the south in the draft LPSP, which would connect Bold Court to Newcastle Street. This connection was not discussed with the owner of the subject site during the preparation of the LPSP. The LPSP was advertised for community consultation showing this connection. Administration is currently reviewing the submissions received on the LPSP and the appropriateness of providing such a connection in this location.

The LPSP is intended to be presented to an upcoming Council Meeting for approval following advertising. The draft LPSP does not form a matter to be given due regard in determining the subject development application, as it is not certain or imminent in coming into effect in the form that it was advertised in.

Regional Centre Zone – Local Planning Scheme No. 2

The objectives of the Regional Centre zone in accordance with Clause 16(1) of LPS2 are:

- To provide a range of services and uses to cater for the local and regional community, including but not limited to specialty shopping, restaurants, cafes and entertainment.
- To provide a broad range of employment opportunities to encourage diversity and self-sufficiency within the Centre.
- To encourage high quality, pedestrian-friendly, street-orientated development that responds to and enhances the key elements of the Regional Centre, and to develop areas for public interaction.
- To ensure levels of activity, accessibility and diversity of uses and density is sufficient to sustain public transport and enable casual surveillance of public spaces.
- To provide residential opportunities within the Regional Centre including high density housing, affordable housing, social and special needs housing, tourist accommodation and short term accommodation.
- To ensure that the centres are developed with due consideration to State Planning Policy 4.2 Activity Centres for Perth and Peel.

Leederville Town Centre Masterplan and Built Form Guidelines

The objectives of the Leederville Masterplan are to:

- Encourage a sustainable density of development into the town centre, while retaining Leederville's unique character.
- Capitalise on the location of the Leederville train station and to ensure development is consistent with the principles of Transit Oriented Development (T.O.D.).
- Provide additional residential and commercial opportunities.
- Increase activation of street frontages.
- Encourage new opportunities for local employment.
- Enhance and maintain the opportunities for education and youth within the town centre.
- Improve the quality, safety and security of the public realm.

The Leederville Masterplan includes the following vision and aim in respect to Precinct 8 – Network City:

• The precinct encompasses the current Water Corporation site and Newcastle Street (from Loftus Street to Carr Place). The masterplan vision sees an intensification and consolidation of development along Newcastle Street. The corner of Newcastle Street and Loftus Street has been identified as a site for a future high rise development.

Delegation to Determine Applications:

The matter is referred to Council for determination as more than five objections were received during community consultation and as the proposal does not meet the deemed-to-comply car parking standards of the R Codes.

RISK MANAGEMENT IMPLICATIONS:

There are minimal risks to Council and the City's business function when Council exercises its discretionary power to determine a planning application.

STRATEGIC IMPLICATIONS:

This is in keeping with the City's Strategic Community Plan 2018-2028:

Innovative and Accountable

We are open and accountable to an engaged community.

SUSTAINABILITY IMPLICATIONS:

The City has assessed the application against the environmentally sustainable design provisions of the City's Policy No. 7.1.1 – Built Form. These provisions are informed by the key sustainability outcomes of the City's Sustainable Environment Strategy 2019-2024, which requires new developments to demonstrate best practice in respect to reductions in energy, water and waste and improving urban greening.

PUBLIC HEALTH IMPLICATIONS:

This does not contribute to any public health outcomes in the City's Public Health Plan 2020-2025.

FINANCIAL/BUDGET IMPLICATIONS:

There are no finance or budget implications from this report.

COMMENTS:

<u>Land Use</u>

The proposed Grouped Dwellings land use is consistent with the objectives of the Regional Centre zone under LPS2 and the Leederville Masterplan for the following reasons:

- The development would contribute towards supporting existing and future non-residential uses within the Leederville Town Centre through the provision of a development that would increase residential population within the town centre area;
- The scale, number and location of the grouped dwellings is consistent with existing development to Carr Place and Bold Court and is compatible with the established built forms in the streetscape that are predominantly residential low to medium rise;
- The proposal would provide residential opportunities within the Regional Centre location. In accordance with 2016 ABS census data, the average household size in Leederville was predominantly one and two persons. The grouped dwellings would contribute to the diversity of two bedroom housing within Leederville to facilitate housing diversity for a range of demographics;
- A mix of dwelling sizes is proposed to provide for diversity of housing typologies to address the varied demographics in the locality which are located in proximity to accessible transport opportunities. The subject site is located approximately 200 metres from high frequency bus routes along Newcastle Street and Oxford Street. There is also a CAT bus route which operates between the Leederville Train Station and the Perth CBD. The Leederville Train Station is located approximately 360 metres from the subject site; and
- The proposed development demonstrates 'best practice' sustainable design as set out in **Attachment 6** through the use of mechanisms such as operable windows for ventilation, water saving fixtures and use of northern aspect, consistent with the local housing objectives of the Built Form Policy related to environmentally sustainable design provision. This is discussed in further detail below. New developments are required to demonstrate 'best practice' environmentally sustainable design under the Leederville Masterplan. 'Best practice' is referred to in the Leederville Masterplan as 4 star under the Green Building Council of Australia (GBCA) rating system.

Lot Boundary Setbacks

The application has also been assessed against the lot boundary setback provisions of the Built Form Policy that sets out deemed-to-comply standards, in addition to an assessment against the deemed-to-comply standards of the R Codes. These lot boundary setback provisions of the Built Form Policy have not been approved by the WAPC and are given regard only in the assessment of the application. The Built Form Policy permits nil lot boundary setbacks for the ground to third storeys of development within the Town Centre built form area.

The development satisfies the deemed-to-comply lot boundary setbacks of the R Codes, with the exception of those detailed below.

Southern Lot Boundary

The proposed lot boundary setbacks of 1.0 metre on the first floor and 1.1 metres on the second floor to the southern boundary for Unit D is in lieu of 1.5 metres and 1.4 metres, respectively, under the deemed-to-comply standards of the R Codes.

The proposed setbacks satisfy the relevant design principles and local housing objectives of the R Codes and Built Form Policy for the following reasons:

- These portions of wall are located adjacent to a car park area for a commercial development located at No. 620 Newcastle Street, Leederville that is similarly zoned Regional Centre. The lot boundary setbacks proposed would not result in bulk or scale impacts to habitable spaces of this non-residential property. The abutting site is located within Precinct 8 (Network City) of the Leederville Masterplan which aims to increase the density of the Newcastle Street commercial area and facilitate high density mixed use development. Any future redevelopment of this abutting site would unlikely be adversely impacted by the proposed setbacks;
- The southern elevation provides stepping of walls to the second floor of the dwelling, and incorporates
 openings to break up the impact of building bulk when viewed from the adjoining commercial property.
 The elevation incorporates contrasting colours and materials including vertical cladding and render that
 assists in breaking up the ground and first floor walls when viewed from the adjoining property to assist
 in mitigating impacts of building bulk;
- Major openings to the southern façade are appropriately screened to alleviate direct overlooking and subsequent loss of privacy to the adjoining property, despite the cone of vision not falling to habitable rooms or active space given that the adjoining area is used for car parking associated with a commercial development; and
- The proposed development satisfies the R Codes deemed-to-comply requirements relating to solar access for adjoining sites. The proposed lot boundary setbacks would not have an adverse impact on the adjoining property's access to direct sunlight or ventilation.

Eastern Lot Boundary

The proposed lot boundary setback of 1.6 metres along the eastern boundary on the first floor of Unit A is a departure to the 2.8 metres deemed-to-comply standard of the R Codes.

The proposed setback satisfies the relevant design principles and local housing objectives of the R Codes and Built Form Policy for the following reasons:

- Openings are proposed to the living room and terrace areas on the first floor of the dwelling, as it presents to Bold Court. This assists to reduce the extent of solid massing and building bulk as viewed from the street and adjoining property;
- The first floor of the dwelling does not project forward of the ground floor building alignment. This would reduce the impact of building mass and ensure that it does not contribute additional bulk;
- The proposed lot boundary setback would abut the front setback area of the existing development at No. 11 Bold Court. The front setback area of this adjoining property does not include any active habitable spaces or habitable rooms which would be impacted by overlooking;
- The proposed development would not result in any departures to the deemed-to-comply standards of the R Codes relating to visual privacy; and
- Given the favourable orientation of the lot, the proposed lot setback would not adversely impact solar access or ventilation to the neighbouring properties.

Landscaping

The amendments to the R Codes which were gazetted on 2 July 2021 require each dwelling to provide one tree within a 2 metre by 2 metre planting area. The minimum dimension for Unit A is 1.0 metre, 1.2 metres for Unit B and 1.8 metres for Unit C. The required planting areas for Units D - I are provided adjacent to the common property access for each of these dwellings.

In addition to the deemed-to-comply standards of the R Codes, the application has also been assessed against the landscaping provisions of the Built Form Policy that sets out deemed-to-comply standards. The deemed-to-comply landscaping standards in the Built Form Policy have not yet been approved by the WAPC and as such, these provisions are given regard only in the assessment of the application.

The proposed tree and planting areas satisfy the relevant design principles and local housing objectives of the R Codes and Built Form Policy for the following reasons:

- The proposed development would meet the deemed-to-comply deep soil area, planting area and canopy coverage requirements of the Built Form Policy. The development would provide for 15.8 percent deep soil and planting areas, and 30.8 percent canopy coverage on site which is located to the front setback, communal access way and side lot boundaries;
- The landscaping plan proposes four different types of trees species including Callistemon, two species of Eucalyptus and Jacaranda trees within the lot boundaries. The City's Parks team has confirmed the size and spacing of the planting areas would ensure the proposed trees are capable of growing to maturity. The Eucalyptus and Callistemon trees are of an evergreen variety, while the Jacaranda is deciduous. This would result in a landscaping outcome which will provide year round canopy and landscaping buffers for the occupants while also offering access to sunlight;
- The minimum dimension for the tree planting areas for Units A C is between 1.0 1.8 metres. This meets the minimum dimension standard prescribed for planting and deep soil areas that are defined as being adequate to support the growth of medium and large canopy trees;
- The landscaping provided to the dwelling would soften the appearance of the proposed development and assist with reducing the overall impact of building bulk and scale when viewed from Bold Court and neighbouring properties. The landscaping provided would also result in canopy which extends outside of the lot boundaries and would contribute to greater urban greening in the locality; and
- The proposed landscaping would contribute to the reduction of the urban heat island effect, increase urban air quality, provide a greater landscape amenity for the locality and create a sense of open space between the proposed dwelling and neighbouring properties.

Car Parking

The amendments to the R Codes which were gazetted on 2 July 2021 requires three visitor parking bays for the development as the deemed-to-comply standard. The development provides for two visitor parking bays, which was consistent with the R Codes at the time the application was lodged with the City.

The proposed visitor parking bays is consistent with the design principles of the R Codes for the following reasons:

- Clause 5.3.3 of the R Codes details that smaller dwellings (either by size or number of bedrooms) may
 have reduced car parking needs. This is based on the premise that smaller dwellings tend to have less
 demand for car parking, as the anticipated occupants per dwelling may be lower. The dwellings consist
 of two bedrooms and may function as a single or two car household. A further reduction to car parking
 standards is also provided for when the dwelling is located in close proximity to convenient public
 transport inclusive of train, bicycle and bus networks. The subject site is located approximately 200
 metres from high frequency bus routes on Oxford, Vincent and Loftus Streets, as well as within 450
 metres of the Leederville Train Station. Additional active modes of transport are also supported by
 pedestrian and cyclist networks;
- The R Codes deemed-to-comply standard requires the provision of nine on site resident bays for the development, being one bay per dwelling. The development would provide for 18 bays located within double garages for each of the dwellings, which exceeds the deemed to comply requirements. The nine surplus resident car parking bays would effectively offset the reliance of the development on existing on-street car parking bays. This is because where resident car parking demand is two bays per dwelling and in excess of the deemed-to-comply standard of the R Codes, the surplus resident car parking bays would ensure this could be accommodated by the on-site parking for the development rather than the use of on-street car parking bays along Bold Court;
- The R Codes visitor parking deemed-to-comply standard applies to the entirety of Western Australia. The City's Draft Accessible City Strategy (ACS) identified vehicle ownership in the City of Vincent (1.48 cars per household) is lower than the Greater Perth Average (1.78 cars per household), with fewer than 50 percent of households owning more than two vehicles. This indicates that households may be moving away from multi-car ownership and would reduce the resident car parking demand on site. Where some of the dwellings proposed are single car ownership, these surplus resident car parking bays would provide an opportunity for residents to allow visitors to access their resident car parking bays;
- There are 72 on-street car parking bays available along Carr Place located within 400 metres walking distance from the subject site via Bold Court. These bays have a 15 minute to 2 hour time restriction between 8:00am and 5:30pm Monday to Friday and 8:00am 12 noon Saturday. These bays are unrestricted outside of these times and are not ticketed. A review of the City's 2018 parking data

indicates that the maximum occupancy of the on-street bays occurred on Wednesdays at 82 percent maximum occupancy to Carr Place. Occupancy of the bays on Friday and Saturday was 73 percent and 69 percent respectively. The average usage of these on-street parking bays during the survey indicates that there is on-street parking available in close proximity to the subject site. Car parking along Bold Court is limited to 2 hour parking anytime, except from 9:00pm – 7:00am which is restricted to residential permits only;

- On site visitor car parking bays are marked and sign posted to be visible and accessible from the street. There is no proposed fencing or vehicle gates which would ensure on-site visitor bays remain open and available from Bold Court; and
- Design principles of the R Codes set out that visitor car parking may be reduced where there is
 adequate on-street parking in the near vicinity of the development. The R Codes deemed-to-comply
 standard for visitor car parking also requires one visitor car bay for every four dwellings. Two visitor
 parking bays would be adequate to cater for the demands generated by the nine dwellings proposed
 having regard for the availability of on-street car parking and public transport options in close proximity
 to the subject site.

Urban Design Study

Clause 5.12 of the Built Form Policy provides local housing objectives relating to the preparation of an urban design study. The Built Form Policy does not include deemed-to-comply standards relating to urban design studies.

The applicant's urban design study details the key built form references and details of the streetscape and surrounding area, and is included as **Attachment 5**. The study identified the following:

- Skillion roof form with awning details to the façade;
- Major openings and balconies address Bold Court to facilitate streetscape engagement, and provide passive surveillance to the street;
- Use of a light colour palette in the rendered finish of the dwelling façade and fixtures is consistent with the surrounding established streetscape;
- Detailing of the roof forms and windows provide a visual link to existing character dwellings along Bold Court; and
- Landscaping and canopy coverage provided in the front setback area and internally to the common access ways.

The proposal satisfies the Built Form Policy local housing objectives relating to urban design study. The development has incorporated design features to ensure that it appropriately references the predominant streetscape and its built form context. This view has also been reflected in the DRP member's comments on the appropriateness of the development proposal.

Environmentally Sustainable Design

Clause 5.11 of the Built Form Policy provides local housing objectives for environmentally sustainable design. The Built Form Policy does not include deemed-to-comply standards relating to environmental sustainable design.

The applicant has submitted an energy efficiency report to satisfy local housing objective 1.8.6 of the Built Form Policy. A copy of the report and environmentally sustainable design template are included as **Attachment 6** and identifies the following built form and site planning measures in the sustainable design of the dwelling:

- Limited stepping of rooms to the internal floor plan to ensure the dwelling is and remains universally accessible and can be easily modified to accommodate changing family size and circumstances. This would ensure the dwelling can evolve over time and remain in place for the future, rather than demolished should living arrangements and needs shift;
- The siting and floor plan layout of the proposed dwelling is established in line with the north-south orientation of the subject site;
- 80 percent global warming potential against target of 50 percent;
- No additional structures, lot boundary walls or significant tree canopy is proposed to the northern elevation so as to not screen areas of north facing openings and open space for maximum natural light and access to winter sun;
- Upper level windows are provided for access to year round natural light;

- Climate moderation devices in the form of eaves and cantilevered upper floor to allow for winter solar penetration and summer shading;
- Openable windows for cross ventilation;
- North facing windows and living areas have been incorporated where practical within the constraints of the site and R Codes provisions to aid in access to light;
- Reduced scale of openings on the western elevation to moderate internal temperatures;
- Living spaces and habitable rooms open to private open spaces for natural and cross ventilation, reducing the reliance on passive heating and cooling devices; and
- The dwellings are constructed of earthy and neutral tones which assist with mitigating solar absorptance and urban heat island effect for the broader locality.


Administration has reviewed the proposal against the Built Form Policy local housing objectives and is satisfied that the development has incorporated environmentally sustainable design features to meet the intended built form outcomes of development within the City.

State Planning Policy No. 5.4: Road and Rail Noise


The purpose of State Planning Policy No. 5.4 (SPP5.4) is to ensure that adverse impacts on the amenity of residential development within proximity of major transport routes is minimised. The subject site is located within 100 metres of Loftus Street and is subject to SPP5.4.


SPP5.4 requires noise attenuation measures to be put in place prior to construction of the development to address noise implications.

Administration has recommended a condition of approval that requires the submission of a Noise Management Plan which is to detail all noise mitigation measures to address SPP5.4 and the mitigation of road noise. This is consistent with the requirements of SPP5.4.

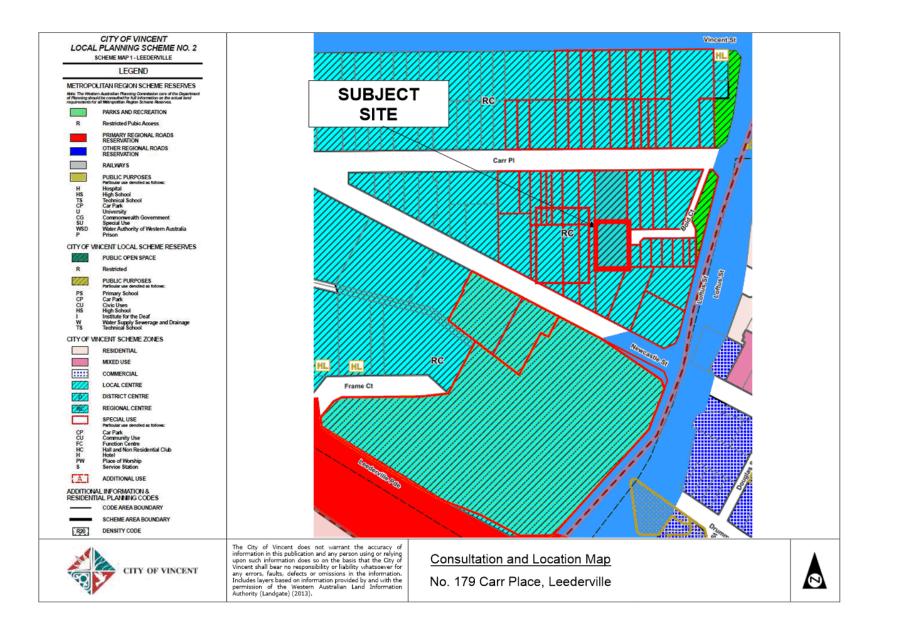



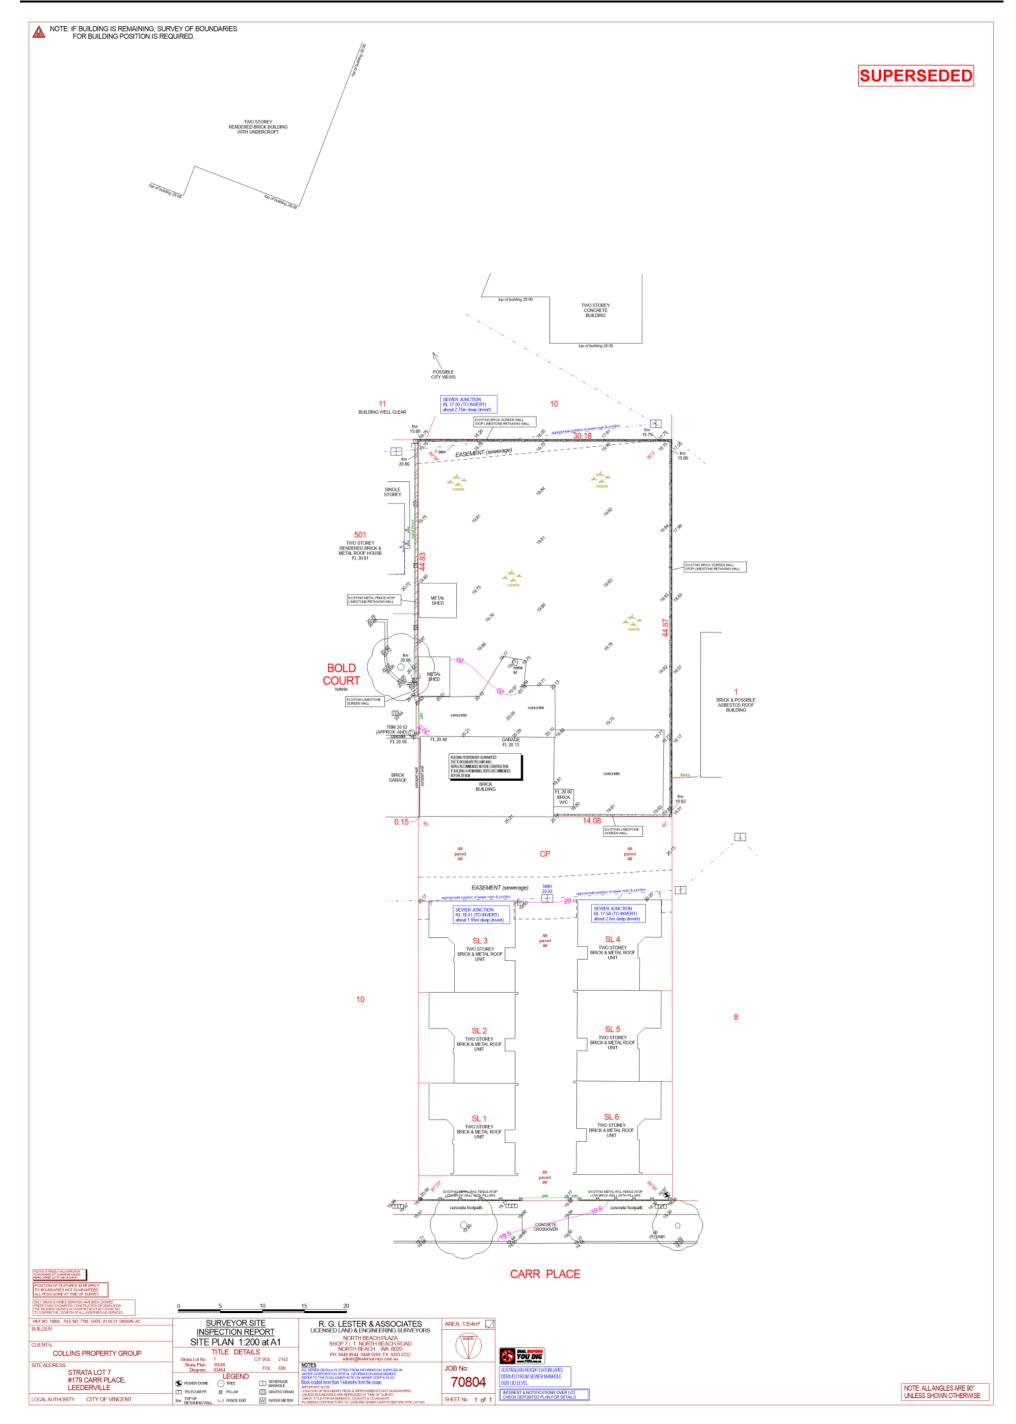

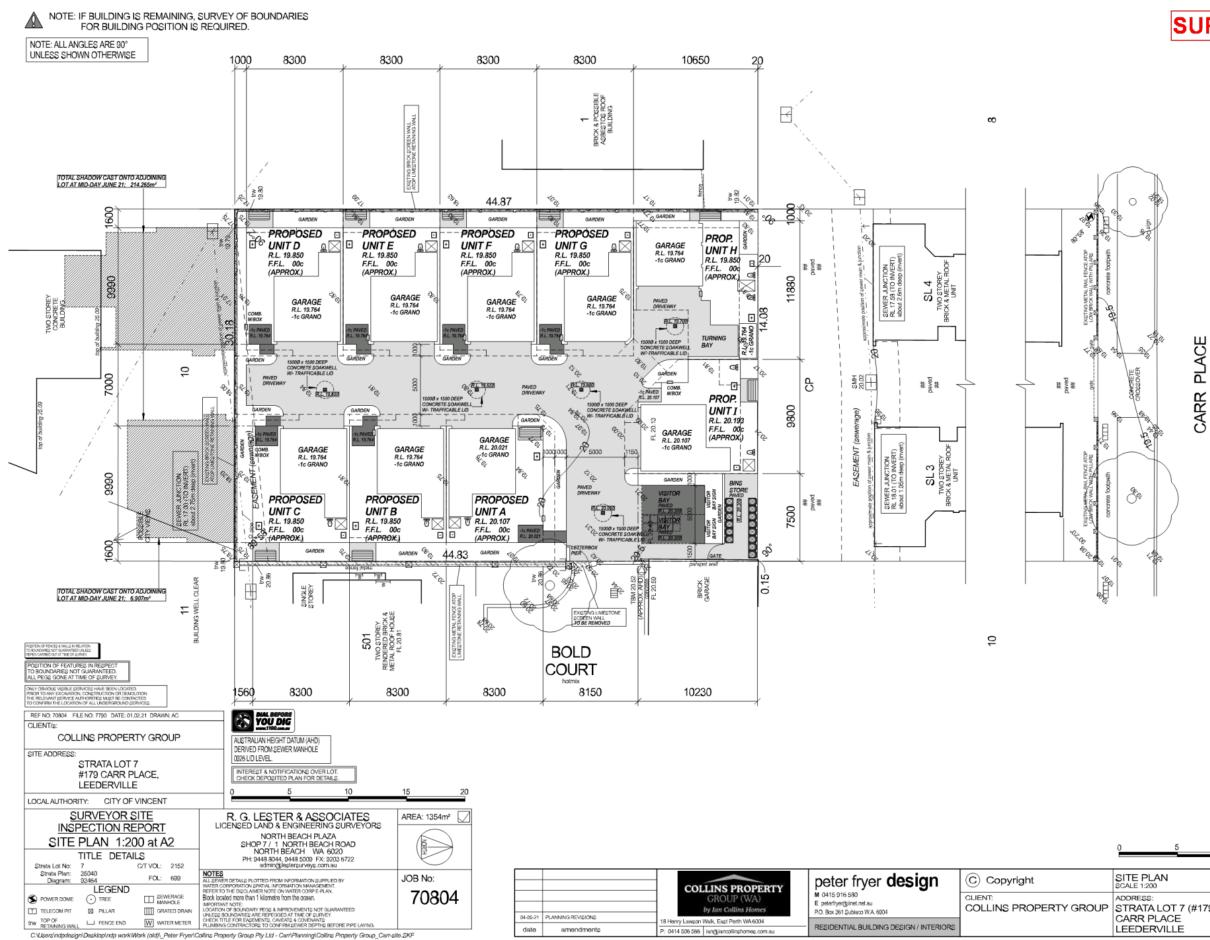

SUPERSEDED

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INS PERTY GROUP	STRATA LOT 7 (#179) CARR PLACE	MARCH 2021 SCALE: AS SHOWN SHEET 2 ^{OF} 10



		COLLINS PROPERTY	peter fryer design		FIRST FLOOR PLAN SCALE 1:100	DRAWN: PJTAYLOR DATE:
		GROUP (WA) by Ian Collins Homes	M 0415 916 590 E peterfryer@iinet.net.au P.O. Box 361 Subiaco W.A. 6904	COLLINS	ADDRESS: STRATA LOT 7 (#179)	MARCH 2021 SCALE: AS SHOWN
date	amendments	18 Henry Lawcon Walk, East Perth WA 6004 P: 0414 506 566 ian@iancollinshomec.com.au	RESIDENTIAL BUILDING DESIGN / INTERIORS	PROPERTY GROUP	CARR PLACE LEEDERVILLE	SHEET 3 ^{OF} 10





		COLLINS PROPERTY	peter fryer design	C Copyright	SECOND FLOOR PLAN SCALE 1:100	DRAWN: PJTAYLOR DATE:
		GROUP (WA) by Ian Collins Homes	M 0415 916 590 E peterfryer@iinet.net.au P.O. Box 361 Subiaco W.A. 6904	CLIENT: COLLINS PROPERTY GROUP	ADDRESS: STRATA LOT 7 (#179)	MARCH 2021 SCALE: AS SHOWN
date	amendments	18 Henry Lawson Walk, East Parth WA 6004 P: 0414 506 566 ian@iancollinshomes.com.au	RESIDENTIAL BUILDING DESIGN / INTERIORS	PROPERTY GROUP	LEEDERVILLE	SHEET 4 ^{OF} 10






	COLLINS PROPERTY	peter fryer design	C Copyright	ELEVATIONS SCALE 1:100	DRAWN: PJTAYLOR DATE:
	GROUP (WA) by lan Collins Homes	M 0415 916 580 E peterfryer@iinet.net.au P.O. Box 361 Subisco W.A. 6904	CLIENT: COLLINS PROPERTY GROUP	STRATALOT 7 (#179)	MARCH 2021 SCALE: AS SHOWN
date	18 Henry Lawson Walk, East Perth WA 6004 P: 0414 506 566 ian@iancollinshomes.com.au	RESIDENTIAL BUILDING DESIGN / INTERIORS	FROPERTI GROOP	LEEDERVILLE	SHEET 6 ^{OF} 10

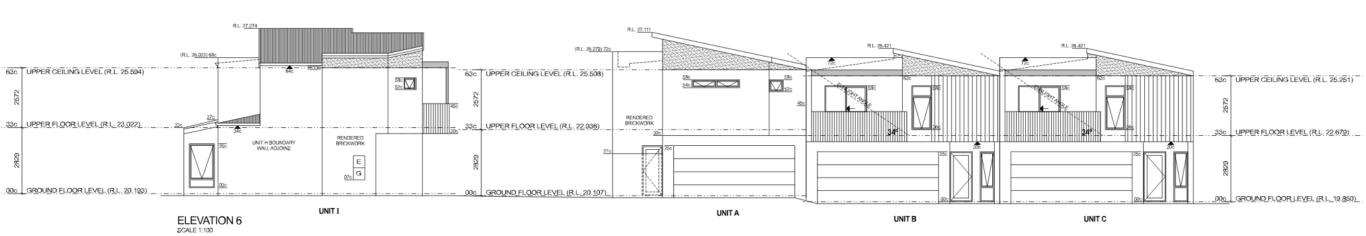

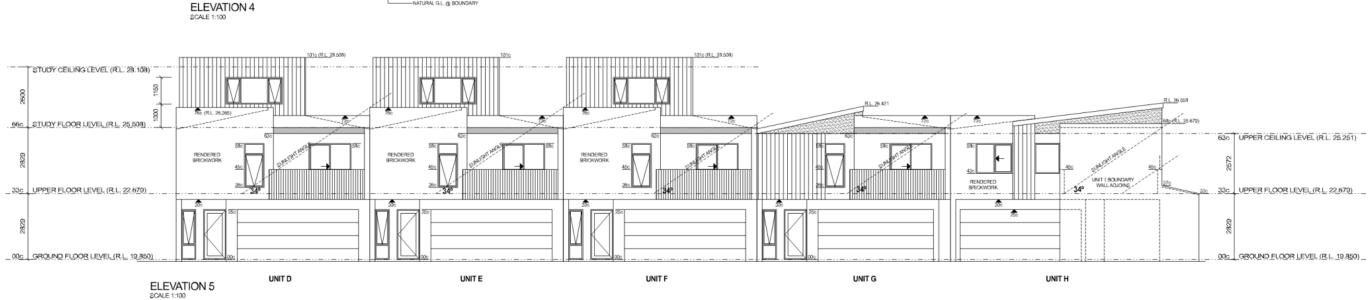

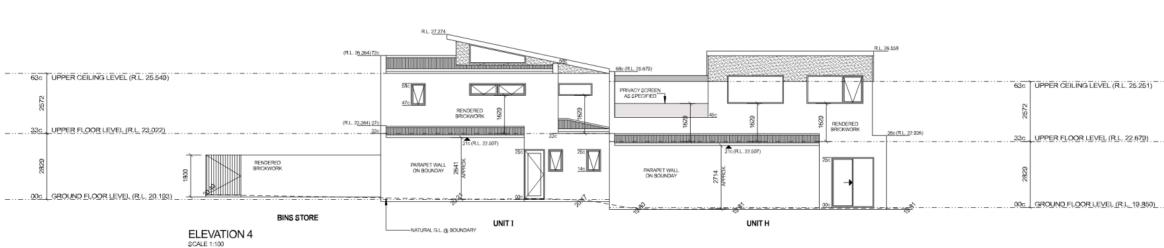

COLORBOND ROOF PITCHED @ 12° 25' (220 RISE: 1000 RUN)

SUPERSEDED

17 AUGUST 2021

COLORBOND ROOF PITCHED @ 12° 25' (220 RISE: 1000 RUN)



date

amendments

by Ian Collins Ho


P: 0414 506 566 ian@iancol

SUPERSEDED

63c	UPPER CEILING LEVEL (R.L. 25.251)
2572	
33c	UPPER FLOOR LEVEL (R.L. 22.679)
2823	
00c	GROUND FLOOR LEVEL (R.L. 19.850)


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		COLLINS PROPERTY GROUP (WA)	peter fryer design M 0415 916 580 E peterfyer@inet.net.au	ADDRESS:	DRAWN: PJTAYLOR DATE: MARCH 2021 SCALE:	JOB No:
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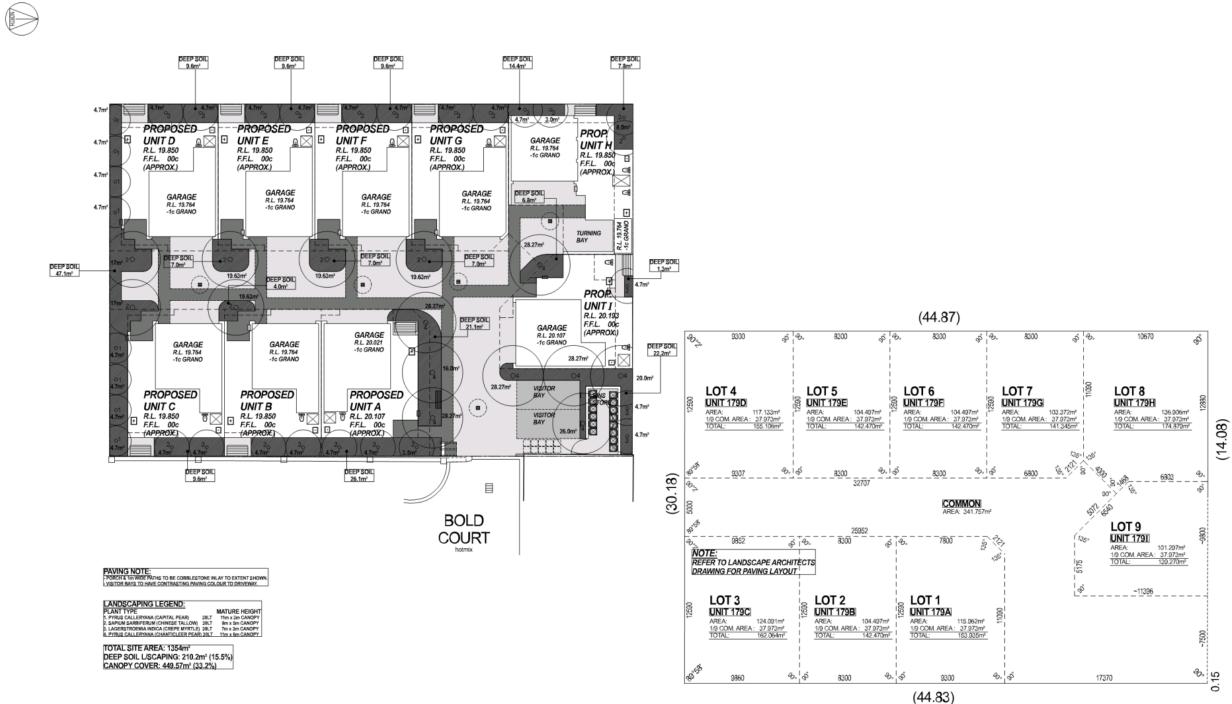


	SITE PLAN SCALE 1:200	DRAWN: PJTAYLOR DATE:	JOB No:		
UP	ADDRESS: STRATA LOT 7 (#179) CARR PLACE	MARCH 2021 SCALE: AS SHOWN			
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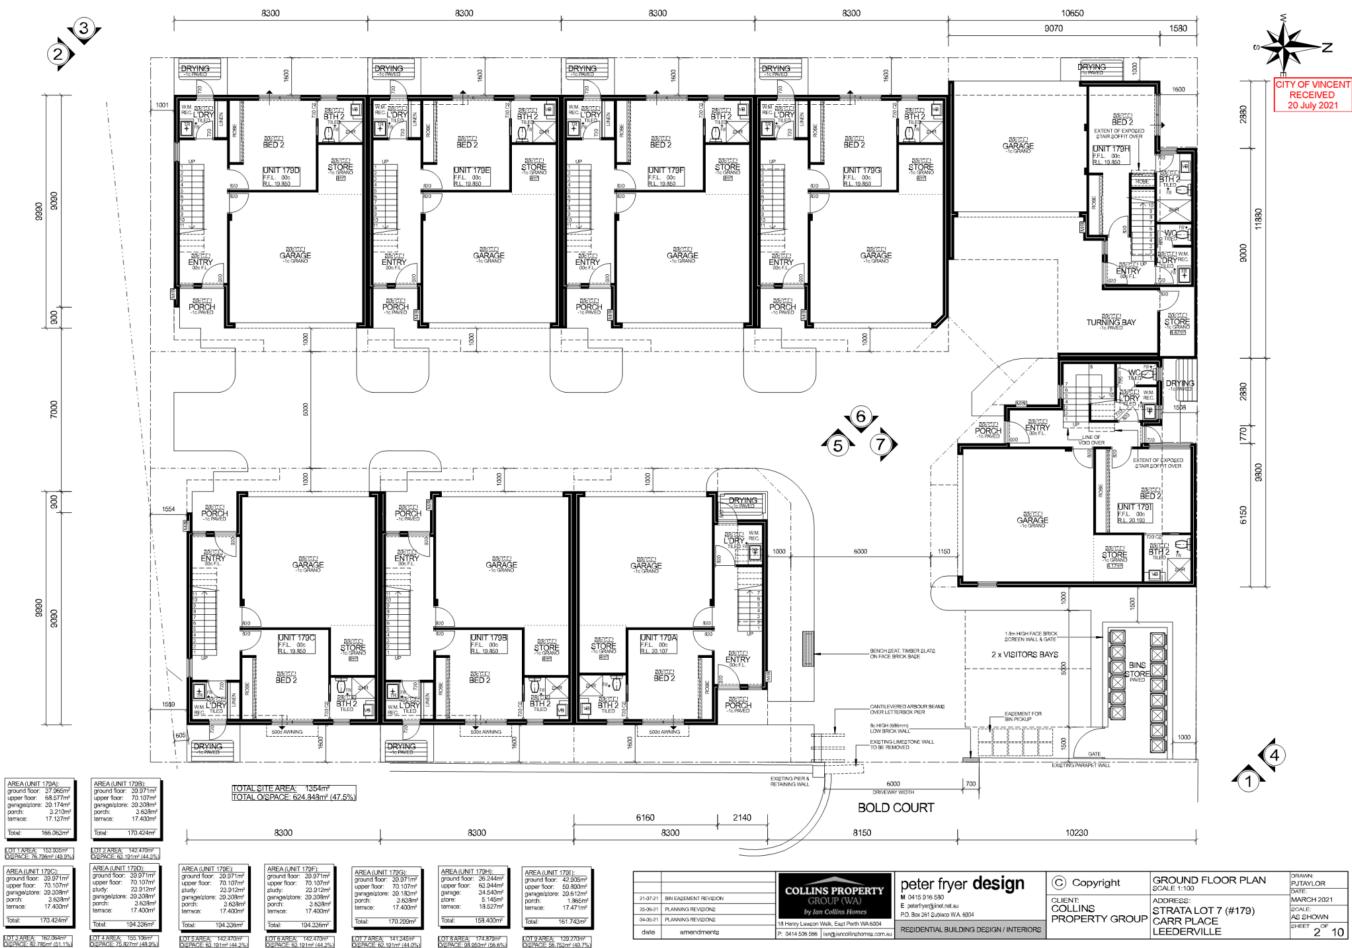
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SITE ALLOCATION PLAN TOTAL SITE SCALE 1:200 AREA: 1354m²

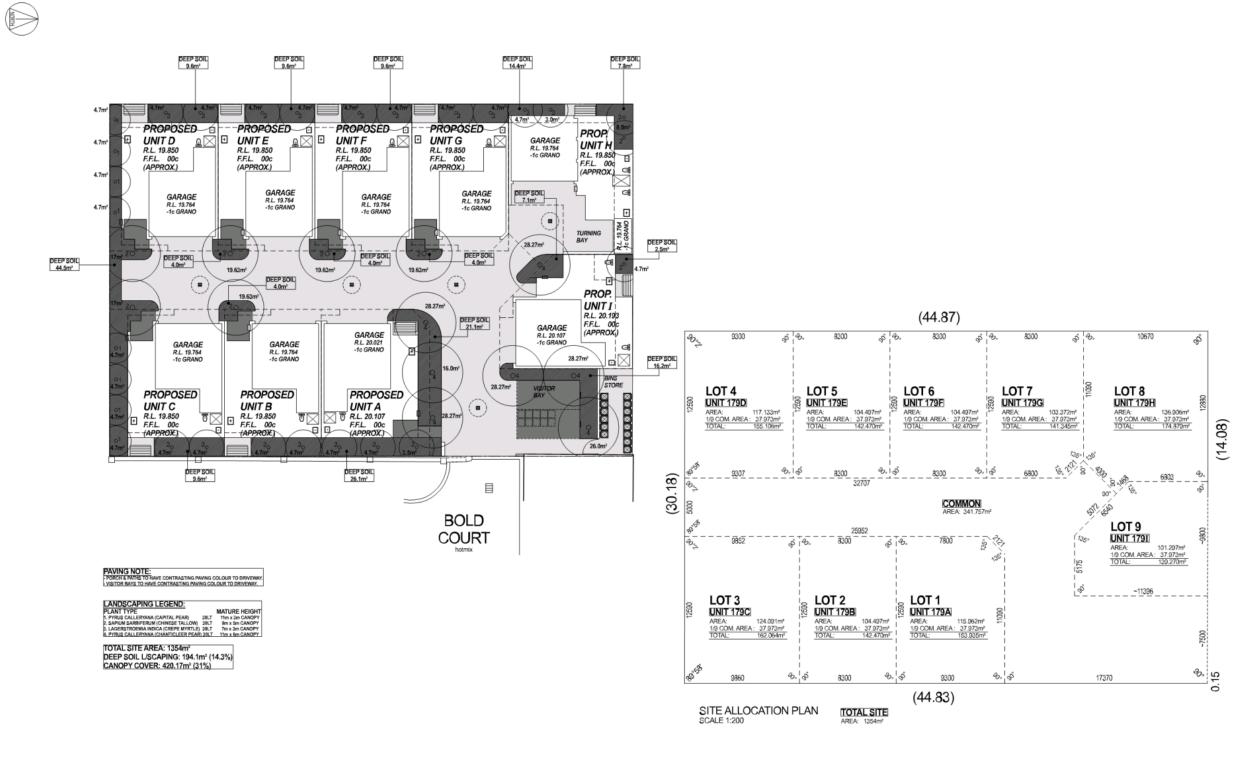		COLLINS PROPERTY	peter fryer design		LANDSCAPING PLAN SCALE 1:200	DRAWN: PJTAYLOR DATE:	JOB No:
21-07-21	BIN EASEMENT REVISION	GROUP (WA)	M 0415 916 580	CLIENT:	ADDRESS:	MARCH 2021	
25-06-21	PLANNING REVISIONS	by Ian Collins Homes	E peterfryer@iinet.net.au P.O. Box 361 Subiaco W.A. 6904	COLLINS PROPERTY GROUP		SCALE:	1
04-05-21	PLANNING REVISIONS	18 Henry Lawson Walk, East Perth WA 6004	P.O. Box 261 Subjects W.A. 6504		CARR PLACE	AS SHOWN	
date	and the second sec	P: 0414 506 566 ian@iancollinshomes.com.au	RESIDENTIAL BUILDING DESIGN / INTERIORS		LEEDERVILLE		^{SHEET} 1a ^{of} 10




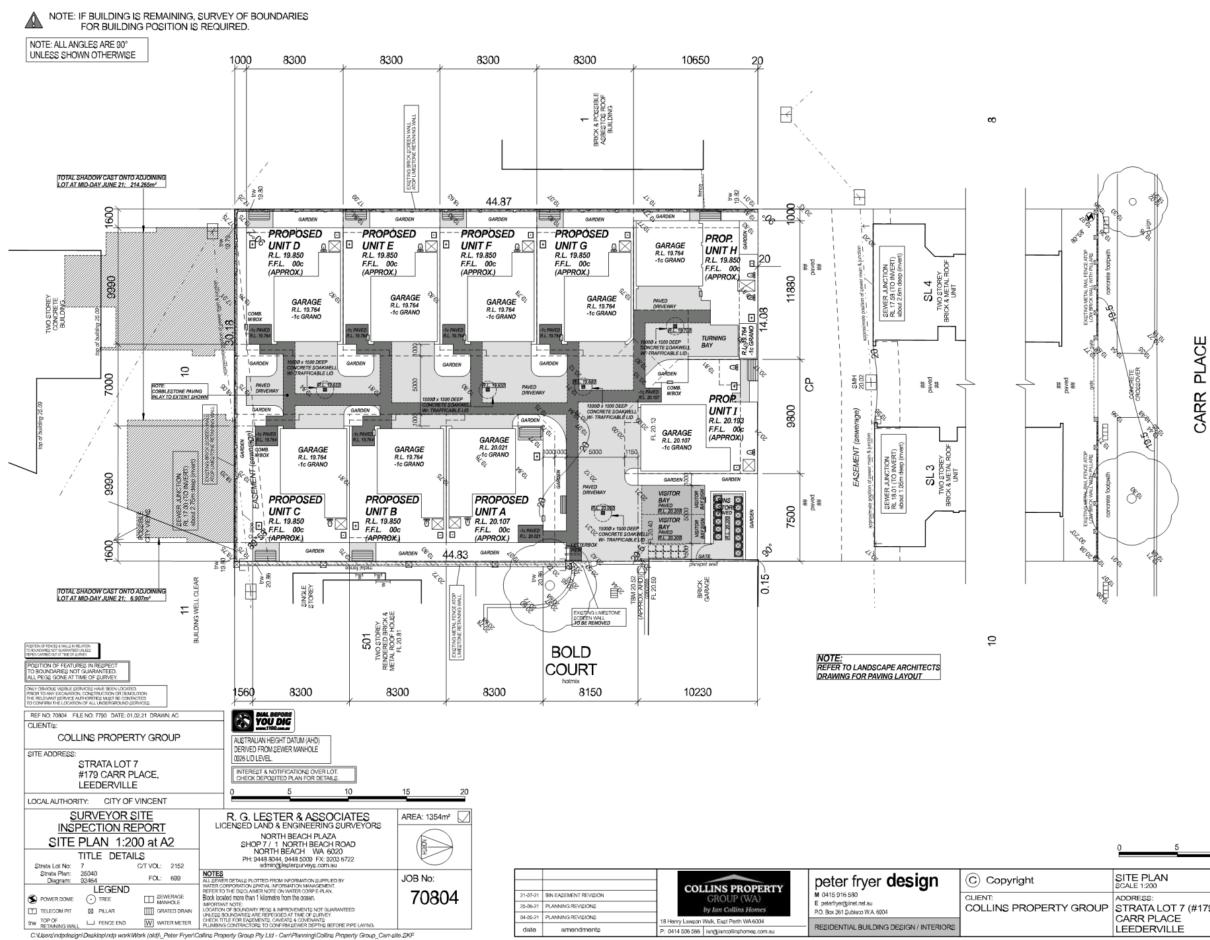

	GROUND FLOOR PLAN	DRAWN:
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NS ERTY GROUP	STRATA LOT 7 (#179) CARR PLACE	MARCH 2021 SCALE: AS SHOWN SHEET 2 ^{OF} 10




		COLLINS PROPERTY	peter fryer design		FIRST FLOOR PLAN SCALE 1:100	DRAWN: PJTAYLOR DATE:
25-06-21	PLANNING REVISIONS	GROUP (WA) by Ian Collins Homes	M 0415 916 580 E peterflyer@iinet.net.au P.O. Box 361 Subiaco W.A. 6904	COLLINS	ADDRESS: STRATA LOT 7 (#179)	MARCH 2021 SCALE:
04-05-21	PLANNING REVISIONS	18 Henry Lawson Walk, East Perth WA 6004		PROPERTY GROUP	CARR PLACE	AS SHOWN
date	amendments	P: 0414 506 566 ian@iancollinshomes.com.au	RESIDENTIAL BUILDING DESIGN / INTERIORS		LEEDERVILLE	3 10

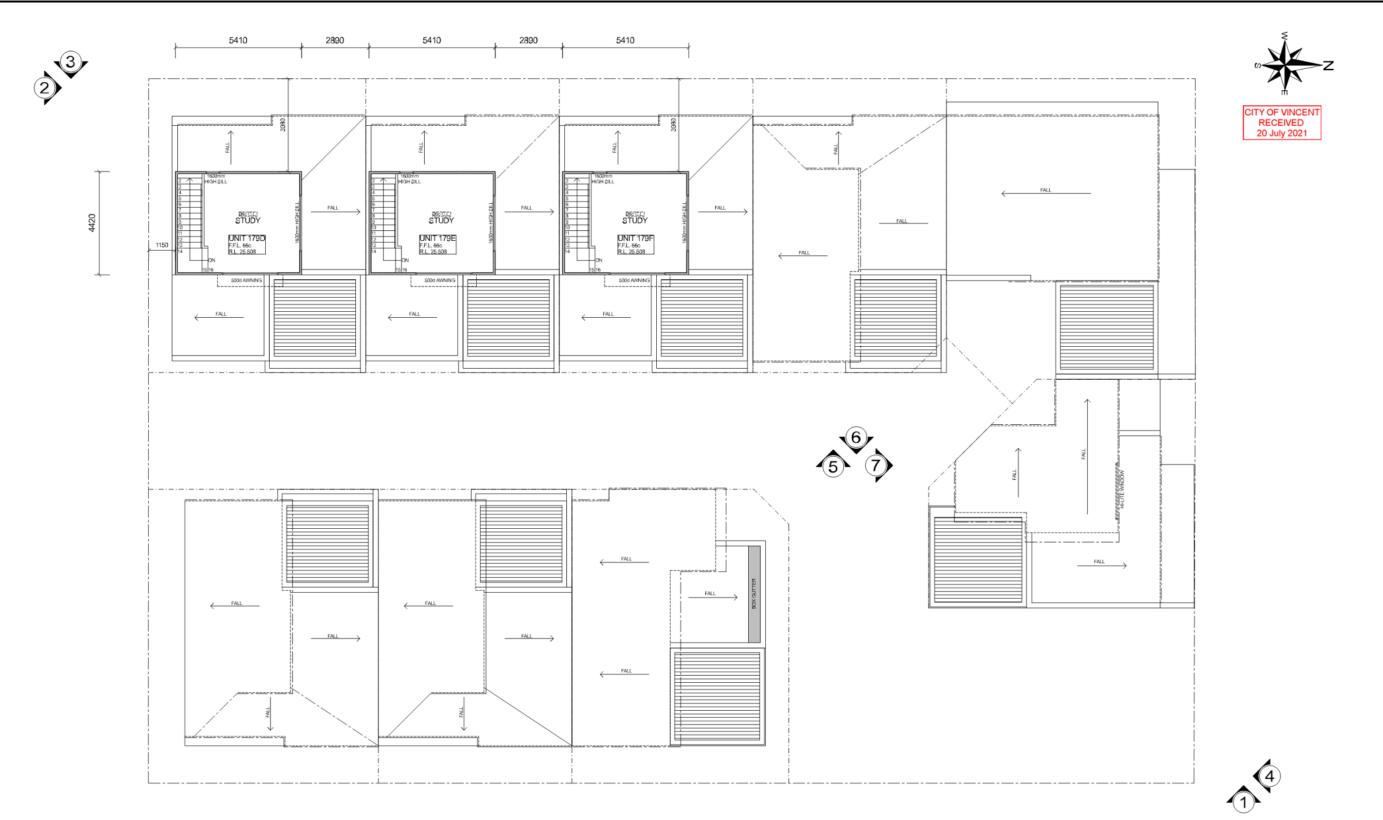

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	PLANNING REVISIONS	18 Henry Lawson Walk, East Perth WA 6004	P.O. Bax 361 Subisco W.A. 6904	PROPERTY GROUP	CARR PLACE	AS SHOWN
date	amendments	P: 0414 506 566 ian@iancollinshomes.com.au	RESIDENTIAL BUILDING DESIGN / INTERIORS		LEEDERVILLE	^{SHEET} 4 ^{of} 10

COLORBOND ROOF PITCHED @ 12° 25' (220 RISE: 1000 RUN)

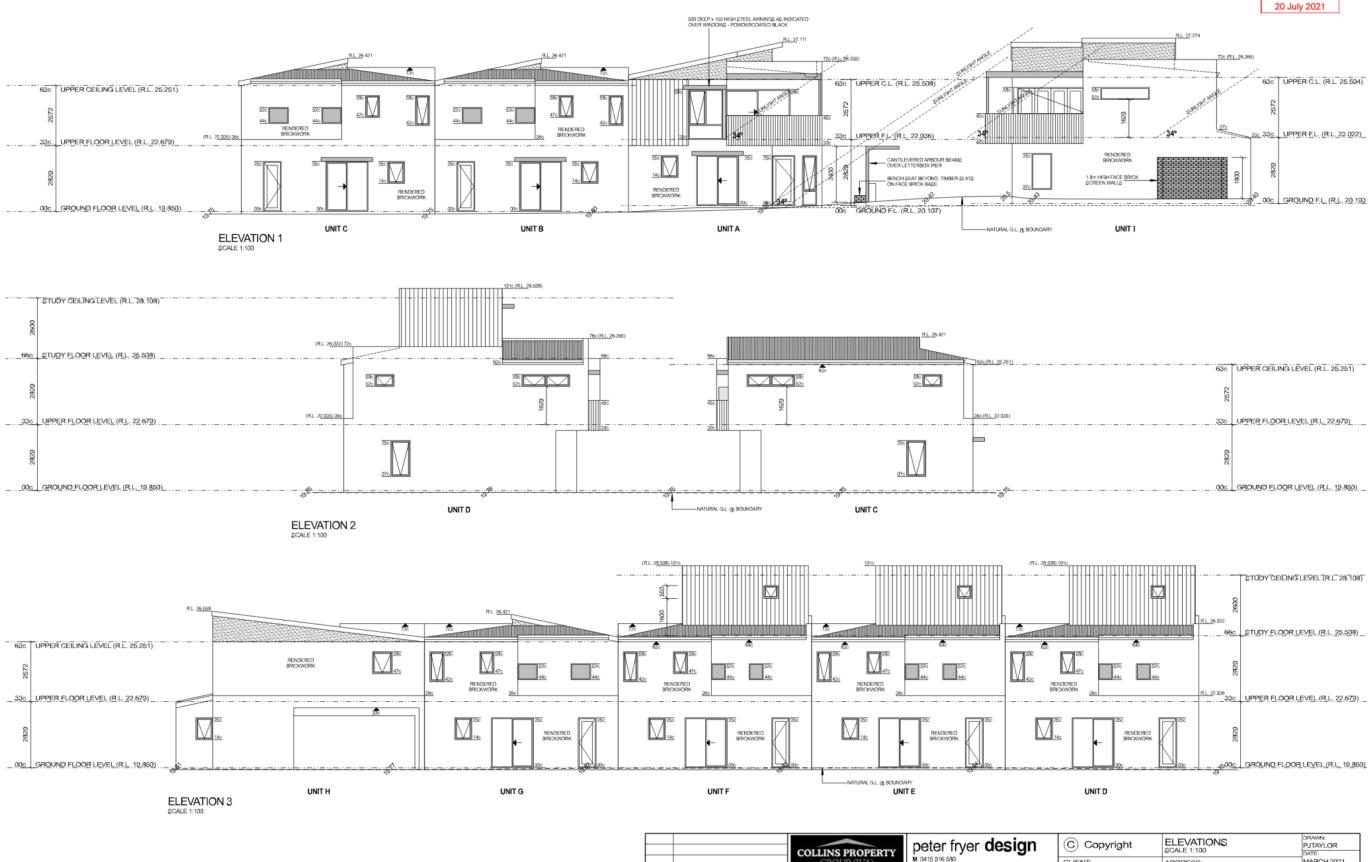

25-06-21 PLANNING REVISIONS

04-05-21 PLANNING REVISIONS

amendments

date

C Copyright	ELEVATIONS SCALE 1:100	DRAWN: PJTAYLOR DATE:
CLIENT: COLLINS PROPERTY GR	ADDRESS: STRATA LOT 7 (#179) CARR PLACE LEEDERVILLE	MARCH 2021 SCALE: AS SHOWN SHEET 5 OF 10


E peterfryer@iinet.net.au P.O. Box 361 Subiaco W.A. 6904


RESIDENTIAL BUILDING DESIGN / INTERIORS

by Ian Collins Home

P: 0414 506 566 ian@iancoll

COLORBOND ROOF PITCHED @ 12° 25' (220 RISE: 1000 RUN)

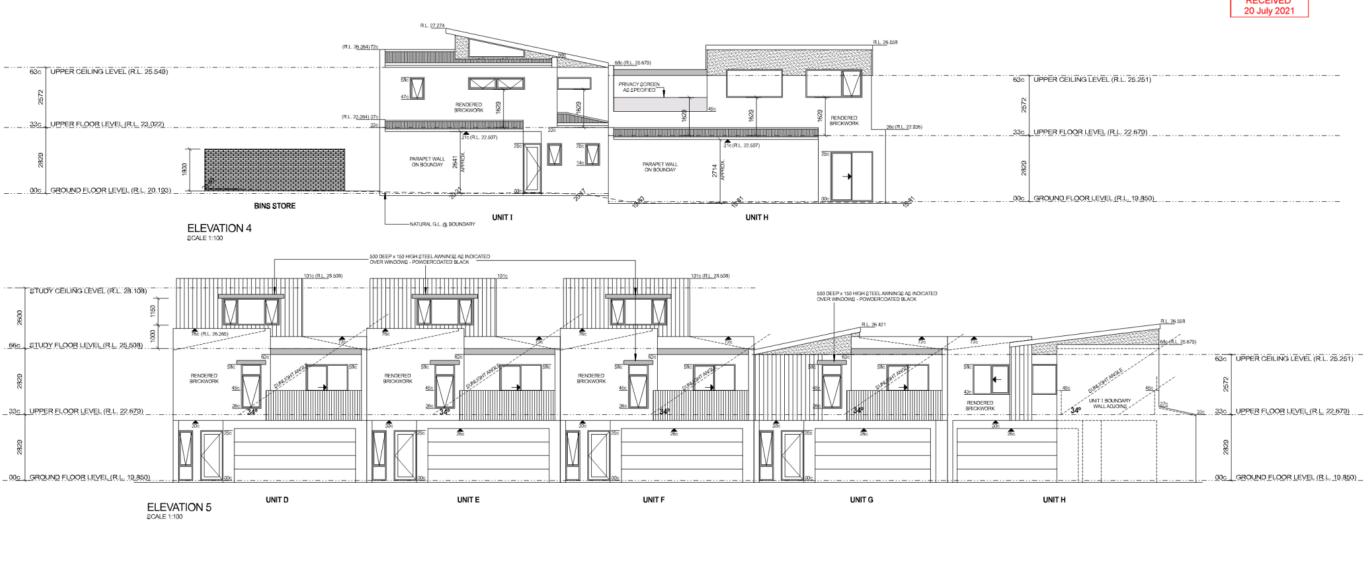

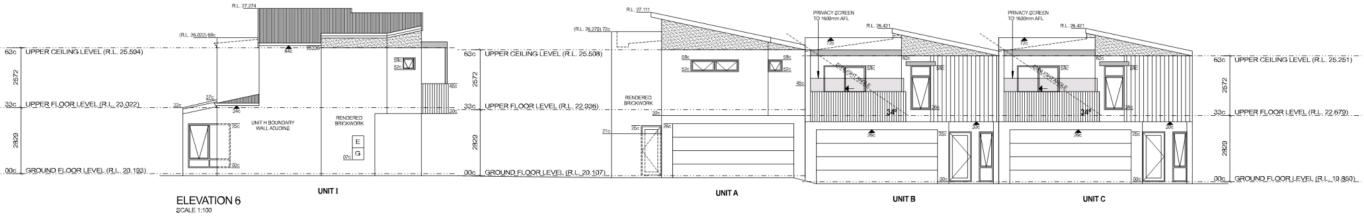

		COLLINS PROPERTY	peter fryer design		ELEVATIONS SCALE 1:100	DRAWN: PJTAYLOR DATE:
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04-05-21	PLANNING REVISIONS	18 Henry Lawson Walk, East Perth WA 6004		PROPERTY GROUP	CARR PLACE	AS SHOWN
date	amendments	P: 0414 506 566 ian@iancollinshomes.com.au	RESIDENTIAL BUILDING DESIGN / INTERIORS		LEEDERVILLE	^{SHEE} 6 [°] 10

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CITY OF VINCENT RECEIVED 20 July 2021
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17 AUGUST 2021

COLORBOND ROOF PITCHED @ 12° 25' (220 RISE: 1000 RUN) UNLESS NOTED OTHERWISE



		COLLINS PROPERTY	peter fryer design		ELEVATIONS SCALE 1:100	DRAWN: PJTAYLOR DATE:
25-06-21	PLANNING REVISIONS	GROUP (WA)	M 0415 916 580 E peterfryer@inet.net.au	0.011.010	ADDRESS: STRATA LOT 7 (#179)	MARCH 2021 SCALE:
	PLANNING REVISIONS	18 Henry Lawson Walk, East Perth WA 6004	P.O. Bax 361 Subisco W.A. 6904	PROPERTY GROUP	CARR PLACE	AS SHOWN
date	amendments	P: 0414 506 566 ian@iancollinshomes.com.au	RESIDENTIAL BUILDING DESIGN / INTERIORS		LEEDERVILLE	SHEET 7 ^{OF} 10



63c UPPER CEILING LEVEL (R.L. 25.504)

33c UPPER FLOOR LEVEL (R.L. 23.022)

00c GROUND FLOOR LEVEL (R.L. 20.193)



date

amendments

P: 0414 506 566 ian@iancollin





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INS PERTY GROUP	ADDRESS: STRATA LOT 7 (#179) CARR PLACE LEEDERVILLE	MARCH 2021 SCALE: AS SHOWN SHEET 8 OF 10


RESIDENTIAL BUILDING DESIGN / INTERIORS



		COLLINS PROPERTY	peter fryer design		FIRST FLOOR AIRFLOW SCALE 1:100	DRAWN: PJTAYLOR DATE:
25-06-21	PLANNING REVISIONS	GROUP (WA) by Ian Collins Homes	M 0415 916 580 E peterfryer@jinet.net.au P.O. Box 361 Subiaco W.A. 6904	COLLINS	ADDRESS: STRATA LOT 7 (#179)	MARCH 2021 SCALE:
04-05-21	PLANNING REVISIONS	18 Henry Lawson Walk, East Perth WA 6004		PROPERTY GROUP	CARR PLACE	AS SHOWN SHEET OF
date	amendments	P: 0414 506 566 ian@iancollinshomes.com.au	RESIDENTIAL BUILDING DESIGN / INTERIORS		LEEDERVILLE	9 [°] 10





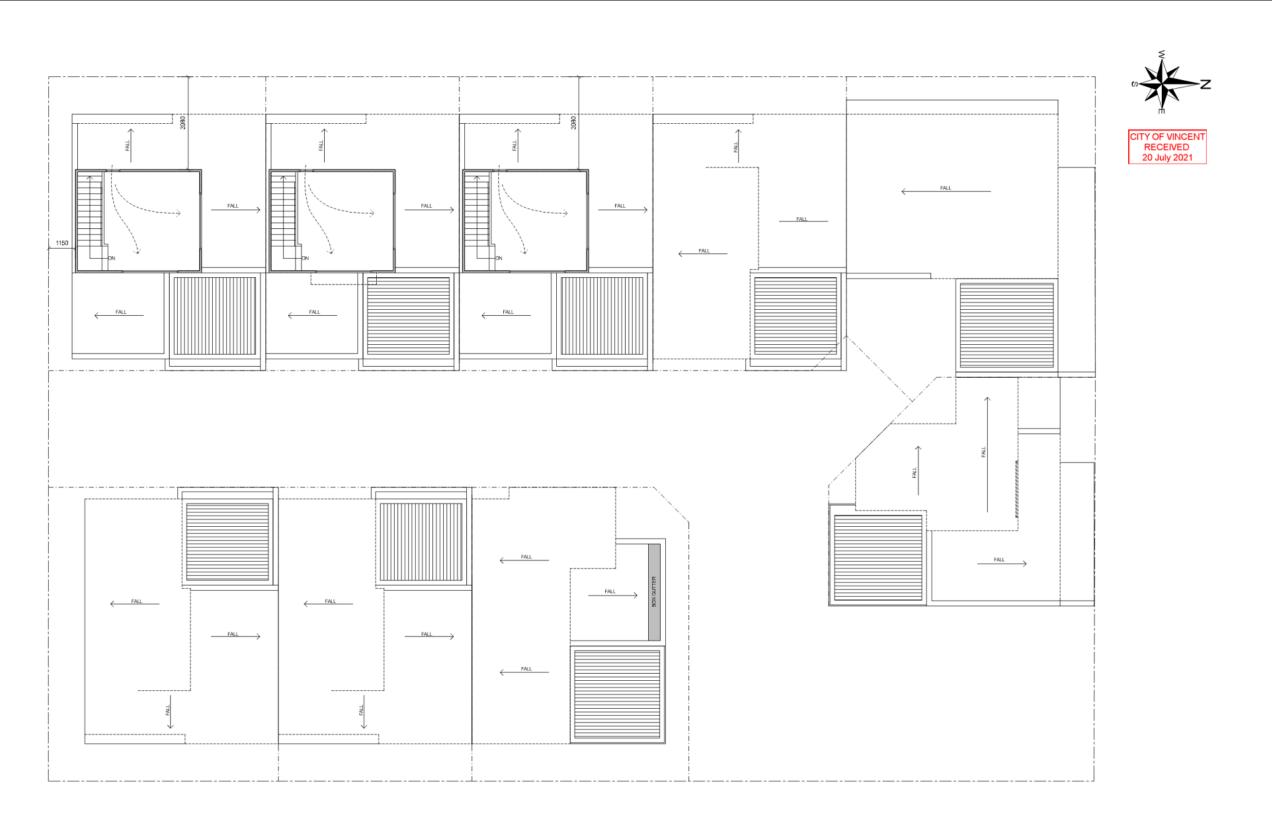

		COLLINS PROPERTY	peter fryer design	C Copyright	SECOND FLOOR AIRFLOW	DRAWN: PJTAYLOR DATE:
26,06,91	PLANNING REVISIONS	GROUP (WA)	M 0415 916 580 E peterfryer@inet.net.au	CLIENT: COLLINS		MARCH 2021 SCALE:
	PLANNING REVISIONS	by Ian Collins Homes	P.O. Bax 361 Subisco W.A. 6904	PROPERTY GROUP	STRATA LOT 7 (#179) CARR PLACE	AS SHOWN
date	amendments	P: 0414 505 566 ian@iancollinshomes.com.au	RESIDENTIAL BUILDING DESIGN / INTERIORS		LEEDERVILLE	SHEET 10 ^{OF} 10

LANDSCAPE MASTERPLAN



GROUND FLOOR SCALE 1:200

Waterwise Planting Key Low Water Consumption A Medium Water Consumption High Water Consumption N Australian Native



A Existing street tree Jacaranda mimosifolia to be retained. 6 Existing verge to be maintained.

8 Proposed pedestrian friendly paving in lighter colour and smoother surface.

PRELIMINARY TREE SELECTION



Kings Park Special






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PAVING MATERIAL



AUTHOR: QY Q.A: GD SCALE: 1:200@A3

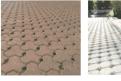PROJECT #: 13077 DATE: JULY 2021 179 CARR PLACE, LEEDERVILLE LANDSCAPE DESIGN

CITY OF VINCENT RECEIVED 20 July 2021

LANDSCAPE DESIGN NOTES

1 Row of Jacaranda mimosifolia and low maintenance native shrubs to provide colour and texture

Private courtyard with small-sized native trees, a mix of flowering shrubs and groundcovers to


6 South side planting bed filled with shade tolerant groundcovers and medium to high shrubs. Proposed trafficable permeable pavers for direct groundwater recharge and minimise tree root









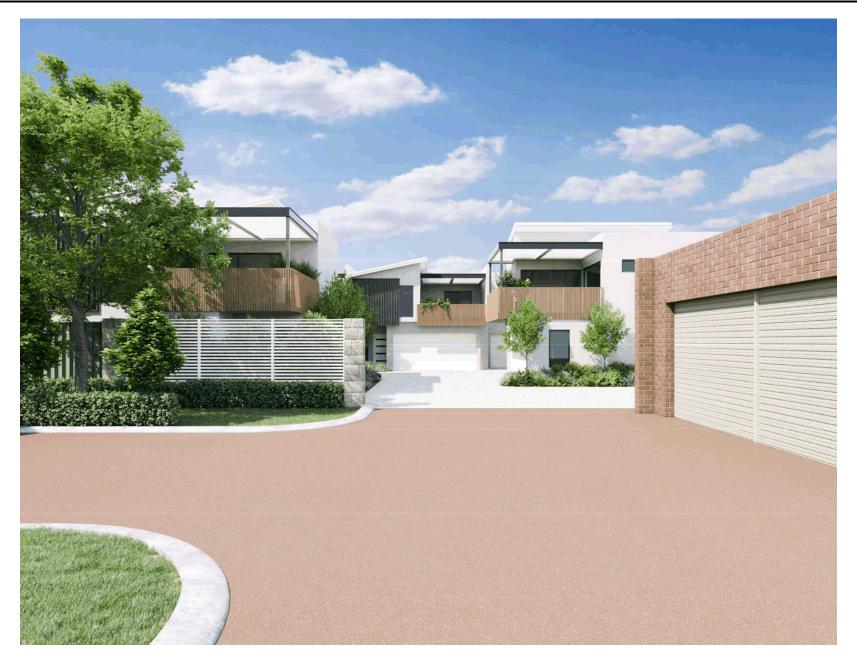







Demonstrate how you have reviewed the natural environment including topography, local flora and fauna.	Leederville is a well established inner city suburb and very small pockets of the natural environment can be found in existing open area. We have had the landscaping plans reviewed by a renown landscaper and they carefully selected plants to suit the proposed development and also meet the requirements of council.
Demonstrate consideration of the site's streetscape character.	This block is very unusual in the fact it comes off Bold Court and basically hidden away. The block is surrounded by nice 2 storey residential houses on Bold Court, commercial behind on Newcastle Street and light industrial on Carr Place. Therefore basically it is only townhouse A that faces the street. We have carefully selected materials to blend in with the surrounding buildings. Townhouse A faces Bold Court with a balcony facing down the street. The remaining townhouses are basically hidden behind townhouse A. We want to create a slice of Leederville inside the complex. (edgey, sharp, funky townhouses)
Demonstrate review of the built and natural environment of the local context to a radium of 400m – 1000m.	179 Carr Place is well located in Leederville and within close walking distance to the popular retain and entertainment hub as well as the Leederville TAFE campus and many other community facilities. It is within 1 km of Leederville train station and within 400 metres of the high frequency bus route on Oxford Street. The block is surrounded by nice 2 storey residential houses on Bold Court, commercial behind on Newcastle Street and light industrial on Carr Place. The proposed developments bulk and height are consistent with the streetscape and comparable developments. Future redevelopment and infill development is inevitable given the current coding.
Demonstrate how the site's context and character influenced the development. Consider the following: History of the local area; Heritage listed buildings in the area; High quality contemporary buildings in the area; Materials, textures, patterns from high quality heritage / character as well as contemporary buildings in	cladding and rendered brickwork in our design. This will give the feel of warehouse/industrial with a funky Leederville funky style.
the area; and Movement patterns / laneways	We have built 7 mini townhouses at 9 Leicester Street Leederville which were greatly received. I think this style of living is missing in Leederville. There are many townhouses, villas, apartments but not a lot of small townhouses that you don't have anyone living above you or below you. The bigger townhouses suit families but we found young professionals and downsizers purchased at 9 Leicester Street Leederville. The use of different materials and materials chosen from

	looking at the street complements the streetscape and history of Leederville I believe.
Demonstrate review of the existing landscaping of the site and the street including mature trees, species and natural features	The existing landscape on the property consists sand. It is basically a vacant block with a few poorly built sheds.
Demonstrate how the landscape quality of the streetscape and surrounding context has been incorporated into the building and landscape design.	As previously mentioned we had a well known Landscaper help with the tree selection for this site. Trees were selected based on the orientation of the sun as well as some screening plants.
What is the building massing and height of the streetscape? How has this been incorporated into the design	Building heights and massing varies throughout the street the adjacent neighbouring buildings are two storey developments. Behind is commercial, on Carr Street is industrial and warehouse style places. Old apartment complexes sit at the end of Carr Place. Materials have been incorporated within the proposed development to go with the warehouse, edgey location it sits in.
How does the development respond and contribute to the built form and scale of the streetscape?	The development is consistent with existing buildings within the street-scape with similar built form to neighbouring dwellings. The street front townhouse is proposed 2 storey as are the townhouses on Bold Court.
Demonstrate how the development encourages an activated and vibrant streetscape environment.	The development is in a very unusual part of Leederville. Basically tucked away from Carr Place coming off Bold Court. We have designed townhouse A to activate with the streetscape. Balcony at the front however it really is an unusual block.
Demonstrate how the proposed design complements the use of the building.	 6 Townhouses are 2 bed 2 bath 2 carbays. This setup is rare in Leederville and is sought after as it has 2 bedrooms (potentially rent with someone) and 2 carbays. Most 2 bed apartments only come with 1 carbay. The balcony is positioned right off the living/dining area which creates another room basically. The vergola system on the balcony adds to the liveability of that area. 3 Townhouses have an office/study on the third floor. We thought people are working from home more and more now would like a townhouse with it's own office setup.
Demonstrate how the building performance has been optimised using suitable orientation and	Double glazing are proposed with a 6 star minimum energy rating. North facing Living areas and courtyards to all dwellings. Minimal West facing windows.
layout of internal spaces. Demonstrate how the development optimises amenity for occupants, adjoining neighbours and onlookers	The proposed grouped dwellings will provide a high level of amenity for the future occupants. All dwellings have an internal living area of around 100 sqm2 plus. It is prefect for young professionals or downsizers as the kitchen, meals, living courtyard and master bedroom are together. Terraces will all

	have operable louvres which will allow usage of this area all year around. 3 townhouses have proposed offices on the third floor which provides options for people needing to work from home.
allow users and visitors to navigate through the	Driveway services the dwellings as per the R-codes. Entrances to the dwellings will be provided with contrasting paving to define the Entrance & front door to each dwelling. Visitor bays at the entrance as well for visitors.
Demonstrate how the layout of buildings on site provides safe and high level of amenity for residents.	Windows at upper and ground floor facing on to the common driveway provides surveillance of the site. Level areas without steps-downs to all units and common areas are provided for safety. All balconies face into common area. As i said before, this site and location is a little unusual.
Demonstrate how the development contributes to a sense of community, encouraging social engagement and enabling stronger communities.	All dwellings have been designed to accommodate a wide range of household types, from single person to young professionals, small families and young professionals. The opportunity to age in place assists in strengthing and maintain the social network in the area and enable friendships to be made and enhanced with both neighbours and friends that live nearby.
Demonstrate how the surrounding context and character has been incorporated into the design of the development.	The design of the proposed development achieves an appropriate builtform and maximises the opportunities of the subject site. 6, two storey grouped dwellings and 3, three storey grouped dwellings are proposed. With the front townhouse having the courtyard at the front facing north and down the street to Bold Court to provide an attractive façade and passive surveillance. A driveway down the middle serving all the townhouses with a strong effort on landscaping will create the best streetscape for the development. The interesting building lines and materials will essentially contribute to the character of the street as well as providing internal amenity. Overall this complex which I think is like a hideaway inside the inner Leederville centre will be an oasis for some warehouse/funky townhouses. Working with an award winning landscaper and taking into account of the streets building materials and then trying to incorporate this will provide a wonderful outcome.

179 Carr Place Leederville Environmentally Sustainable Design

The City's Built Form Policy includes Local Housing Objectives related to achieving a development which incorporates Environmentally Sustainable Design (ESD) principles.

These principles seek to achieve new developments which have a reduced environmental impact, improved energy and water efficiency, and reduced reliance on non-renewable energy sources. The development of energy efficient buildings also delivers medium to long-term savings for owners and occupants.

By considering these principles of ESD through the development application process, a more holistic approach can be taken towards incorporating ESD principles into the building design, rather than retrospectively once the building design has been completed.

The Local Housing Objectives in the Built Form Policy are performance-based, which requires consideration as to how each of these have been achieved.

To assist landowners and applicants in preparing a development application, the below table outlines the Local Housing Objectives applicable to Single Houses and Grouped Dwellings, and information on how these can be addressed through principles of ESD.

For further information and further examples of what you could provide, please refer to the City's Environmentally Sustainable Design Information Sheet HERE. Alternatively, feel free to contact the City's Development and Design team on 9273 6000.

Please outline how each of the following elements have been addressed and attach any relevant or supporting photos, images, diagrams or drawings where applicable.

What Does This Mean and How Can I Achieve This?	Applicant Comment – How I have achieved this objective
Environmental Impact	
Development that considers the whole of life environmental impact of the buil	ding and incorporates measures to reduce this impact.
The environmental impact of developments can be impact by considerations such as building orientation, design and construction materials. Construction materials which are durable and are low maintenance generally have a low environmental impact.	At 179 Carr Place Leederville we have chosen building materials that are both recycled and low maintenance. A mixture of rendered brickwork, colourbond Lysaght longline 305 claddings and aluminium timber batten cladding has been selected for this development.
 Some examples of building materials and design choices with reduced environmental impacts include: Incorporating an east-west orientation (where possible); Minimising the extent of the building footprint; 	The building footprint is not excessive and within the requirement of this land zoning. We haven't tried to get extra area as we would like to have nice sized boutique 2 bedroom townhouses.

What Does This Mean and How Can I Achieve This?	Applicant Comment – How I have achieved this objective
 Incorporating good solar-passive design; Reverse brick veneer (internal thermal mass, external insulation); Low emission concrete; Lightweight, recycled, non-toxic, minimally processed and recyclable materials; Gabion walls filled with demolition waste; High quality (durable), energy and water saving fixtures and fittings (such as reversible ceiling fans, water efficient taps and toilets); and Installation of appropriate and effective insulation. 	Ceiling fans are proposed in all the bedrooms as well as cavity insulation, solar panels and we will be choosing water efficient taps and toilets. Hi light windows have been designed above the vergolas to provide good northern light into the living area. Vergolas have been selected on the balconies to provide get option to either allow the sunlight in, or block out the summer heat.
Thermal Performance Development that optimises thermal performance of the building throughout t	the year through design elements and material selection.
 Development that optimises thermal performance of the balance throughout a strategic use of air gaps). 	 179 Carr Place has all the courtyards facing north along with a hi lite window above, this orientation allowing for the best heating and cooling possible. Vergola systems in the courtyards have been proposed to also help block out the sun in summer which will help stop the heat as well. In winter the vergola can open to allow for sunlight and heat to get over a fixed courtyard roof. Cavity insulation like aircell is proposed for the development in between the double brick walls to help the overall thermal performance. Anticon is also proposed to be installed under the metal roof to help the thermal performance. R4 batts are to be installed in all ceiling areas as well to help with the thermal performance.

What Does This Mean and How Can I Achieve This?	Applicant Comment – How I have achieved this objective
Solar Passive Design	
Development shall incorporate site planning principles that maximise solar pas	ssive design opportunities for both summer and winter
 Where the long axis of building runs east-west, the majority of glazing being provided to the north, with limited glazing provided to the east and west; and/or The inclusion of a central light well or courtyard can help to maximise access to northern light. 	The courtyards and major opening are to the north. Therefore helping the solar passive design. Limited windows have been placed on the west. Sunlight and ventilation have been incorporated in the design as well.
Sunlight and Ventilation	
The provision of natural ventilation and daylight penetration to reduce energy	consumption
 Rooms provided with ventilation openings on both sides to allow cross-flow of air; Maximum glazing provided to north-facing living areas; Bedrooms being located on the south; and/or Utility rooms and garages being located on east and west sides of a dwelling. 	As previously mentioned, the vergola to the courtyard and hi light window above the vergola will allow daylight penetration into the liveable areas.
Solar Heating	
The provision of daytime areas with north-facing glazing to allow passive solar	r heating during winter
 Up to 80% of the glazing provided to north facing living areas being unshaded in winter, and fully shaded by external structures in summer. 	As mentioned below, the courtyards are all to the north with the major openings facing this way. Vergolas are proposed to further help the ability to block out the summer sun however allow winter sun in with the ability to open the vergolas. Something you wouldn't get from a fixed structure.
Cross Ventilation	
The provision of openable windows and/or ceiling fans to habitable rooms or o	accupied spaces that allow natural and cross ventilation
 Windows located on north and south side of the dwelling being openable to utilise cooling breezes in summer; and/or Reversible ceiling fans facilitate cooling in summer and improve air dispersion for more efficient heating in winter. 	Living door is suggested to be bi-fold which will allow for ventilation. Openings to bed 1 also will allow some cross ventilation. Awning windows to the kitchen windows will help with the cross ventilation. Ceiling fans in all bedrooms and living areas will help ventilation as well.

What Does This Mean and How Can I Achieve This?	Applicant Comment – How I have achieved this objective
Water Re-use	1
The provision of recovery and re-use of rainwater, storm water, grey water an	d/or black water for non-potable water applications
 Rainwater captured in tank/s above or below ground and plumbed into toilet and laundry; Greywater used for garden irrigation, or hand basin draining into toilet cistern for flushing; and/or 	Greywater systems are being looked at, and we will proceed on this depending on the budget. We have achieved the councils requirement on soft landscaping which will maximise the onsite stormwater infiltration.
• Soft landscaping is maximised to increase on-site stormwater infiltration.	
Solar Gain	
Incorporation of shading devices to reduce unwanted solar gain in summer an	
 Eaves, pergolas and other external shade structures designed to the 	As previously mentioned.
correct depth to provide 0% shading in mid-winter and 100% shading in	
mid-summer.	The courtyards have vergolas proposed. Like our other developments w
 Such structures may also be movable, (e.g. mobile screens and 	find people love these as it has the ability to allow shade in summer and
adjustable pergolas) to allow increased control over light and heat gain.	still allow sunlight in when you want.
Energy Consumption	1
Integration of renewable energy and energy storage systems to optimise ener	gy consumption.
• Solar photovoltaic system (with or without battery storage) for electricity generation;	Solar panels are proposed for this development.
 Solar or heat pump hot water system; and/or 	We will wire the house so that battery storage to the solar panels can be
• Smart-wired home to enable automated diversion of excess solar energy	easily achieved.
to power air conditioners and other appliances and reduce energy use at	
other times.	Fans are to be installed in all bedrooms and living areas to also allow air
	conditioning systems to not be turned on all the time.

What Does This Mean and How Can I Achieve This?	Applicant Comment – How I have achieved this objective
Solar Absorptance	
Flat roof structures that are not visible from the street or adjacent properties	shall have a maximum solar absorptance rating of 0.4
or .	
Pitched roof structures or roof structures that are visible from the street or ad	jacent properties shall have a maximum solar absorptance rating of 0.5,
unless a suitable alternative is identified in the Urban Design Study	
Solar absorptance rating is a measure of how much solar energy a material	179 Carr Place Leederville is a mixture of skillion roof with shale grey
absorbs and therefore how hot it gets when exposed to the sun. A rating of	metal roof proposed. (light colour).
zero means no absorption and the material remains cool. A rating of 1 is	The Three storey townhouses will have a skillion roof and concealed root
100% absorption and the material becomes very hot.	Both will be light colour
As a general rule, light roof colours have lower absorptance values than dark	This would provide a low absorptance value.
oof colours. Roofing material suppliers can provide the absorptance values	
of their colour range.	Along with cavity insulation, anti con and ceiling batts, this development
	will provide a very low absorptance value.
Roofs that are visible from the street or adjacent properties are permitted a	
nigher absorptance value because lighter colours (which have lower	
absorptance values) may be visually less comfortable for some neighbours.	
Environmental Performance	
Demonstrate that the development is capable of achieving the following perfe	ormance standards when compared against the Perth statistical average fo
residences:	
• 50% reduction in global warming potential (greenhouse gas emissions); ar	ıd
50% reduction in net fresh water use.	
The acceptable method for demonstrating this is an independently reviewed	EN15978 compliant Target Setting life cycle assessment (LCA) with a 20%
actor of safety applied to improvement strategies	
actor of safety applied to improvement strategies	
Applications for new Single Houses and Grouped Dwellings should be	

What Does This Mean and How Can I Achieve This?	Applicant Comment – How I have achieved this objective
performance of the building over its lifetime, to understand how the design	
contribute towards reduced environmental impacts.	
You can find an LCA assessor by contacting the Australian Life Cycle	
Assessment Society (ALCAS) or by doing a general internet search. Please	
ensure that you or the assessor you engage use methodologies compliant	
with:	
 Environmental standard EN15978 – Sustainability of construction works 	
 Assessment of environmental performance of buildings – Calculation method; and 	
• That the system boundary includes all Life Cycle Modules (A1-2, B1-7, C1-	
4 and D) in addition to non-integrated energy (plug loads).	
As an alternative to the LCA for Single and Grouped Dwellings, the City may	
accept an 8 star <u>NatHERS</u> rating, in conjunction with the development	
meeting the other local housing objectives listed above.	
The City can also consider other environmental sustainable design reports,	
however it is recommended these be discussed with the City prior to	
engaging someone, to ensure that the report will be accepted by the City.	
engaging someone, to ensure that the report will be accepted by the City.	

Please complete all sections of this template and send to mail@vincent.wa.gov.au along with all relevant attachments. Alternatively, you can submit your application in person at our Administration Centre (244 Vincent Street, Leederville) or post to PO Box 82, Leederville, 6902.

Compliance Checklist

Performance Summary



Global Warming Potential, GWP (Life Cycle)

(凸) 80% Saving against a target of 50%



Net use of fresh water, FW (Life Cycle)

(凸) 50% Saving against a target of 50%

Performance Detail

	Internal Material & Construction	Use Stage Materials & Construction	Integrated Energy Use	Plug Load Energy Use	Water Supply & Treatment	End of Life	Recycling & Energy Export	Total
Global Warming Potential, G	WP (kg CO ₂ eq / occup	oant / year)						
Benchmark	865.7	542.9	939.5	822	165.5	135.2	-75.82	3395
Proposed Design	617.4	397.8	-366.4	816.1	96.26	99.23	-970.7	689.7
Difference	248.3	145.1	1306	5.886	69.33	35.99	894.8	2705
Life Cycle Savings	7%	4%	38%	0%	2%	1%	26%	80%
Net use of fresh water, FW (kg / occupant / year)								
net use of neon mater, i m (kg / occupant / year)							
Benchmark	kg / occupant / year) 3754	1804	1202	1757	83170	616	-286	92019
		1804 1879	1202 -1070	1757 1745	83170 42950	616 418.5	-286 -2588	92019 45640
Benchmark	3754							

Building Attributes

Highlighted information denotes that changes were made from the "baseline design" and should be an area of focus for compliance checks.

179 Carr Place, Leederville



Dwellings:	9			
Bedrooms:	19.5			
Bathrooms:	19			
Car parks:	18			
Floors:	3			
Type of carpark:	Garage			
Ceiling Height:	2.6			
Gross Floor Area:	1380			
Occupancy Date:	01/09/2021			

Energy Supply and Efficiency Attributes

Electricity Supply:	Mains Connected
Thermal Rating:	NatHERS 6.0 Star
Energy Monitoring:	No Energy Monitoring
Natural Lighting:	Normal

Water Supply and Efficiency Attributes

Water Supply:	Mains Supply	
Water Treatment:	Mains Connected	
Shower Heads:	4 star (4.5 - 6L/m plus spray force and coverage tests)	
Toilets:	4 star (4.7L/flush, 3.2/haif flush, 3.5L/average flush)	
Tapware:	6 star (1.0 - 4.5L/min)	
Washing Machine:	4.5 star (9.5L/kg clothing washed)	
Dishwasher:	5.0 star (8.57L/wash for 10 place setting dishwasher)	
Garden Type:	Dripper garden bed and no lawn	
Rainwater Pump Type:	Undefined	

Building Components

Highlighted information denotes that changes were made from the "baseline design" component type, or changes were made to the default quantities and should be an area of focus for compliance checks.

Integrated Services

Component Type	Quantity
Cooking Appliances	
Cooking, Res Electric Stove and Oven	9 Cookers
Hot Water System	
Gas Instantaneous Hot Water System (HWS_App)	9 Gas instantaneous hot wat
Indoor Lighting Fitout	
LED Residential Lighting (Standard Efficiency)	9 Household
Cooling System	
Split System Air Source Heat Pump for Cooling (MEPs Average, R32)	9 heat pump(s) 5kW
Heating System	
Split System Air Source Heat Pump for Heating (MEPs Average, R32)	9 heat pump(s) 5kW

Plug Loads

Component Type	Quantity
Refrigeration	
Refrigeration, Residential Well Ventilated Fridge Recess Less than 800mm Width (AUS)	9 Refrigeration Energy Use
Dwellings	
Appliances Residential Average (AUS)	9 eTool: Average Household

Outdoor Services

Component Type	Quantity
Renewable Generation	
Solar PV System Residential - Zone 3 (Perth Sydney etc)	36 KW
Outdoor Lighting Fitout	
LED Outdoor Lighting (Residential - Standard Efficiency), m2	325 m2 of outdoor lit area
Swimming Pool Temperature Control	
Swimming Pool Seasonal Temperature Control - No Pool Cover - Gas	0 Pool Surface Area
Swimming Pool Filtering	
Swimming Pool - Pumps and Filters Ultra Efficient	0 m2 surface area
Swimming Pool Structure	
Pool Structure - Concrete	0 m2 pool surface area

Structure

Component Type	Quantity
Ground Floor Area	
Concrete Floor - 100mm slab on ground 30MPa 3.8% reo (Portland Cement)	661.32 eTool: m2 of floor slab
Upper Floor Area	
Concrete Floor - 230mm elevated slab, 40MPa, 3.8% reo	718.69 m2 of floor slab
Stairs	
Staircase, Concrete (40Mpa, 2% reo by volume)	18 m stair rise
External Wall Area	
Wall External Type 1, Masonry, double brick 110-50-110 insulated with foundations and finishes	900
Glazed Area	
Windows Residential Aluminium Single Glaze fly screen	270.15
Roof Area	
Roof - TimberTruss/SteelSheeting/25degreePitch	760.52
Entry Doors	
Door - SolidCoreTimber/SteelJam/Painted (#)	18 eTool: Number of Doors
Internal Doors	
Door - HollowCoreTimber/SteelJam/Painted	40.5 Door
External Wall Area	
Wall, External, Masonry and Framed. Reverse Brick Veneer steel clad insulated with foundations and finishes	159
Internal Wall Area	
Wall Internal Type 1, Masonry, Single Brick Wall (90mm) uninsulated with foundations and finishes	534.22
Internal Wall Area	
Wall Internal Type 2, Masonry, Single Brick Wall (90mm) uninsulated with foundations and finishes	437.16

Finishes

Component Type	Quantity
Living Areas	
Floor Finish - Grind+Polished Concrete	381.22 m2 of internal floor
Kitchens Dining Areas	
Floor Finish - Grind+Polished Concrete	466.99 m2 of internal floor
Wet Areas	
Floor Covering - Tiles (ceramic/5mm)	104.74 eTool: m2 of internal flo
Bedroom Areas	
Floor Covering - Carpet (glue down/Nylon)	260.68 eTool: m2 of internal flo

3.3	Item 3.3
	Address: 179 Carr Place, Leederville
	Proposal: Nine (9) Grouped Dwellings
	Applicant: Jason Collins, Ian Collins Home Pty Ltd
	Reason for Referral: Lodged DA
	The proposal would benefit from referral to the Design Review Panel to consider departures
	to the City's Policy No. 7.1.1 – Built Form (Built Form Policy) and Residential Design Codes
	(R Codes), and the appropriateness of the development within its setting.

DRP Comments (19 May 2021)		
Design quality evaluation		
		Supported
		Pending further attention – refer to detailed comments provided
		Not supported
	\square	Insufficient information for comments to be able to be provided.
Strengths of the Proposal		
 Sensitive design approach within the context Well-articulated dwellings form and scale Combination of dwelling forms (two and three storey) is sound 		
Design Principles		

nciple		
Good design responds to and enhances the distinctive characteristics of a local		
area, contributing to a sense of place.		
nt façade and appearance of dwelling as viewed from Bold Court		
sider recycled brick as an option, this is grittier and may tie in more with the Leederville text and character		
Principle		
od design recognises that together landscape and buildings operate as an		
egrated and sustainable system, within a broader ecological context.		
reased areas of landscaping could be incorporated across the site of trees to the actual buildings and their proximity to development > potential to ease setback to enhance growth and the greening experience rove the garden experience on the ground floor. Is a 7m width required between the age doors and vehicle movements, and could this be revised to increase depth of ting areas within the common driveway areas		
spectives indicate on structure planting – need to clarify and demonstrate on plans if is the intent		
nciple		
od design ensures that the massing and height of development is appropriate		
its setting and successfully negotiates between existing built form and the		
ended future character of the local area.		
3 storey height of the development is consistent with and below the permitted heights ne Leederville Masterplan and the Built Form Policy		
eriality and colour choices are well selected but refinement is required.		
 Scale and massing of development is acceptable 		
nciple		
Good design meets the needs of users efficiently and effectively, balancing		
nctional requirements to perform well and deliver optimum benefit over the full -cycle.		
ages taking up a lot of space – are 2 bays required for all of the dwelling? Opportunity to the on-site parking for a couple of the developments to increase building footprint for dwellings G - Ability to flip the site planning of dwelling addressing Bold Court to provide a greater or appearance so there are additional openings or landscaping h ground floor boundaries further from the access way. This will increase on site open		
ce and landscaping opportunities		
nciple		
od design optimises the sustainability of the built environment, delivering sitive environmental, social and economic outcomes.		
k of sun shading to all openings which may provide some harsh sun to internal		
ces. Shading devices may be incorporated		
gola's to terraces on the upper floor is a sounds outcome. Re-orientate the louvre ctionality as these currently open to the east and will not allow sufficient access of light and ventilation to terraces		
ours to be refined to reduce glare.		
nciple		
od design optimises internal and external amenity for occupants, visitors and ighbours, providing environments that are comfortable, productive and healthy.		
 H – setback, double garage and turning bay. Slim ground floor profile which does not a dvantage of the northern aspect and creates poor internal amenity. Could consider rnal planning to try and capitalize on the site better I – bed 2 has no external window. Should revise. Bath also has no windows enity of the 2 most northern units and opportunities to consider more efficiency race for Unit I – located to the south which is a missed opportunity for access to ural sunlight and ventilation. 		
i I - eni rac		

Principle 7 -	Principle
Legibility	Good design results in buildings and places that are legible, with clear connections and easily identifiable elements to help people find their way around.
	 Pedestrian access, movements and pathways required Pedestrian experience – is a gate or pedestrian gate proposed? Development sees you go from road/vehicle approach of Bold Court to the development is there a way to increase the experience for the pedestrian. How do you build that in. goes to the landscaping extent and locations as well Materiality of the pedestrian access way from Bold Court which appears 'softer' and lead to a common pedestrian leg. May consider differing paving between vehicle and pedestrian ways
Principle 8 - Safety	Principle Good design optimises safety and security, minimising the risk of personal harm and supporting safe behaviour and use.
	 Consider manoeuvering bay for Unit H – can this be revised to maintain sight lines but reduce vehicle parking areas/hardstand Dwelling provide interface and interaction with streetscape. No perceived concealment
Principle 9 - Community	Principle Good design responds to local community needs as well as the wider social context, providing environments that support a diverse range of people and facilitate social interaction.
	 The site location lends itself to the pedestrian experience but double garages are the main product. Should consider this relationship Terraces of Units which are directly adjacent each other – ability to offset the locations or these so they are not directly aligned with one another. Will provide a zig zagged floor planning and limit direct line of sight to neighbouring properties Public Art or contribution to the locale for community benefit?
Principle 10 - Aesthetics	Principle Good design is the product of a skilled, judicious design process that results in
	 attractive and inviting buildings and places that engage the senses. Trying to get some more of the Leederville contextual elements built into the material and elements
Other comment	s provided by the DRP
Unit G. Oppor landscaping, a	e development as viewed from Bold Court – line of sight on approach is to the double garage tunities to soften this approach and the pedestrian interface from Bold Court. Additional additional openings and a flipped floor plan (view to entry) may be a better opportunity a store should be reviewed and if possible and compliant
Other general c	omments provided by the City
 Increase the f Sewer line tra footing design Provide the he According to A garage height Based on the (only A to F un Site is located carriageway to development management 	calculations and canopy growth neight/opening of the garage doors/openings verse through Unit C. The developer needs to liaise with the Water Corporation regarding the requirements. eight of the Letter box and utility meters locations. AS2890.1, minimum vertical clearance to the garage entrance is 2.2 meters. Increase the from 25C to 26C. swept path analysis, the garage setback area needs to be marked as access easement area hits). I within proximity of major routes (Loftus Street – 6 lanes) – 72m distance from road to lot boundary. As per State Planning Policy 5.4 (SPP5.4), <i>Noise-sensitive land-use and/or is acceptable, subject to: Mitigation measures in accordance with an approved noise plan; or quiet house package as specified.</i> Applicant to confirm what recommendations will be within the DA plans to address.

Conclusion

- Adjust design (plans) to improve amenity of apartments (as outlined above)
- Review selection of materials use of face brick (paving to driveway)
 Reviewing shading devices to openings (windows)

Reviewing shading devices to openings (windows).

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Summary of Submissions:

The tables below summarise the comments received during the advertising period of the proposal, together with the City's response to each comment.

Comments Received in Support:	Administration Comment:
Development Scale	
 Support the proposed development because the design, density and height appear appropriate for the area. The built form outcome and layout would attract families to the area and is a better alternative to apartment developments. 	Noted.
Comments Received in Objection:	Administration Comment:
Lot Boundary Walls	
Need to ensure a box guttering system is in place for any future maintenance can be totally contained within the proposed development property.	The development inclusive of lot boundary walls is to ensure that stormwater is contained on site which is to be secured through a condition of approval. The applicant has confirmed box gutters are to be installed to walls on the boundary to contain stormwater.
Vehicle Access	
 Access from Bold Court will increase the daily traffic. Bold Court essentially becomes a one way street due to street parking. There is greater potential for pedestrian accidents to occur. 	The development site is landlocked and does not have access to Carr Place under the subdivision approval issued by the Western Australian Planning Commission (WAPC). This requires the use of Bold Court to provide vehicle access to the site, which is consistent with the requirements of the Residential Design Codes Volume 1.
 The application seeks to increase current usage of the Bold Court by more than double (200%). Use of Bold Court for access will diminish utility and increase safety and road traffic risk for Bold Court occupants. The current ability of children to play safely in their front yards will be significantly impacted. 	It is acknowledged that the use of Bold Court to access the development would increase traffic movements along this road. The WAPC's Transport Impact Assessment Guidelines identify that developments of less than 10 dwellings would have a low impact on traffic movements. As the proposed development consists of nine dwellings, the additional traffic generated by the development is appropriate having regard to these guidelines.
	The proposal demonstrates the required sight lines to ensure pedestrian and vehicle safety is maintained for vehicle egress to and from the site.
Leederville Masterplan	
The Leederville Master Plan mentions subdivision of blocks is generally not supported unless exceptional circumstances have been met including to allow for improved safety or design of roads. Substantially increasing the traffic on Bold Court seems contradictory to the master plan statement.	The Leederville Master Plan does not provide for limitations on the subdivision on land, and Administration notes this comment relates to the Draft Leederville Precinct Structure Plan (LPSP). It is acknowledged the LPSP is currently only in draft form and may be subject to change. Notwithstanding, the LPSP identifies the subject site as a Residential R80 site. The grouped dwellings proposed are consistent with the City's Local Planning Scheme No.2 and LPSP by achieving a variety of housing typologies of a higher density within proximity of the Oxford Street Town Centre area and the Leederville Train Station. The subdivision of the lot is for functional purposes to separate the vacant land from the established grouped dwellings as they address Carr Place.

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Summary of Submissions:

Comments Received in Objection:	Administration Comment:
Subdivision	
 Provisions should have been made to allow for entry from Carr Place to a Carr Place property. This impacts people who purchased on Bold Court by massively increasing the traffic. An easement over the front driveway to Carr Place ought to be sought through any subdivision to accommodate vehicle access from Carr Place. 	The application address is noted as Carr Place as the new titles and street addressing for the property have not yet been issued by Landgate. The new development will be given a Bold Court address and there will be no connection to Carr Place.
Construction Management	
Building construction will significantly impact residents for an extended period of time. Have any other provisions of access been thought of to accommodate the construction of the townhouses?	As the only direct access point to the site, Bold Court is to be the primary vehicle access route during construction. A condition requiring a construction management plan to be prepared, submitted to and approved by the City prior to issue of a building permit has been included as a recommended condition of approval.
	A construction management plan would ensure effective management of building work and on-site construction, particularly waste management, storage of construction materials, parking arrangements for contractors and subcontractors, and traffic and access management to minimise disruption to and impact on the surrounding area.
Bin Store	
Object to the location and necessity of the bins store for the proposed development, which is in close proximity to my residence. Better practice would be the requirement for each dwelling to store	WALGA's <i>Multiple Dwelling, Waste Management Plan Guidelines,</i> do not apply to grouped dwellings.
bins on their own premises and not have a common bin storage area. The reasons are obvious as having bins in a common area is subject to health, hygiene and noise concerns, as per WALGA's <i>Multiple Dwelling, Waste Management Plan Guidelines</i> .	The applicant has liaised with the City's Engineering team to accommodate a bin store which meets the City's standards and can be collected by the City's waste service. To provide a distinct separation between the bin store and neighbouring properties, the applicant has provided a solid brick wall and a landscaping buffer to the northern boundary. The bin store would abut the garage wall of No. 175 Carr Place and the onsite parking bays for existing development at No. 179 Carr Place, whereby the dwellings are setback 8.5 metres from the bin store area. The bin store would not abut any existing outdoor living areas or habitable rooms and would not adversely impact on the amenity of these adjoining properties. The bin store area would also be required to comply with requirements <i>City of Vincent Health Local Law 2004</i> which would further assist in this reqard.

Note: Submissions are considered and assessed by issue rather than by individual submitter.

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Determination Advice Notes:

- This is a development approval issued under the City of Vincent Local Planning Scheme No. 2 and the Metropolitan Region Scheme only. It is not a building permit or an approval to commence or carry out development under any other law. It is the responsibility of the applicant/owner to obtain any other necessary approvals and to commence and carry out development in accordance with all other laws.
- 2. With reference to Condition 2, the owners of the subject land shall obtain the consent of the owners of relevant adjoining properties before entering those properties in order to make good the boundary walls.
- 3. With reference to Condition 5, the visual privacy requirements of Clause 5.4.1 C1.2 of the R Codes Volume 1 states that "screening devices such as obscure glazing, timber screens, external blinds, window hoods and shutters are to be at least 1.6m in height, at least 75 percent obscure, permanently fixed, made of durable material and restrict view in the direction of the overlooking into any adjoining property".
- 4. With reference to Condition 6, the City encourages landscaping methods and species selection which do not rely on reticulation.
- 5. With reference to Condition 7, no further consideration shall be given to the disposal of stormwater 'offsite' without the submission of a geotechnical report from a qualified consultant. Should approval to dispose of stormwater 'offsite' be subsequently provided, detailed design drainage plans and associated calculations for the proposed stormwater disposal shall be lodged together with the building permit application working drawings.
- 6. The proposed crossover levels shall match into the existing footpath levels. Should the footpath not be deemed to be in satisfactory condition, it must be replaced with in-situ concrete panels in accordance with the City's specification for reinstatement of concrete paths.
- 7. With reference to Condition 9, all new crossovers to the development site are subject to a separate application to be approved by the City.
- 8. The premises to be provided with a suitable enclosure for the storage and cleaning of refuse receptacles. The enclosure is to be provided with:
 - a. a tap connected to an adequate supply of water;
 - b. adequate ventilation to remove objectionable odours;
 - c. of sufficient size to accommodate all receptacles used on the premises but in any event having floor area not less than 3 square metres;
 - d. constructed of brick, concrete, corrugated compressed fibre cement sheet or other material of suitable thickness approved by the City;
 - e. having walls not less than 1.5 metres in height and having an access way of not less than 1 metre in width and fitted with a self-closing gate;
 - containing a smooth and impervious floor:
 - of not less than 75 millimetres in thickness; and
 - which is evenly graded to an approved liquid refuse disposal system and
 - which is easily accessible to allow for the removal of the receptacle.
- 9. A Road and Verge security bond for the sum of \$2,000 shall be lodged with the City by the applicant, prior to the issue of a building permit, and will be held until all building/development works have been completed and any disturbance of, or damage to the City's infrastructure, including verge trees, has been repaired/reinstated to the satisfaction of the City. An application for the refund of the security bond shall be made in writing. The bond is non-transferable.

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Determination Advice Notes:

- 10. The movement of all path users, with or without disabilities, within the road reserve, shall not be impeded in any way during the course of the building works. This area shall be maintained in a safe and trafficable condition and a continuous path of travel (minimum width 1.5 metres) shall be maintained for all users at all times during construction works. If the safety of the path is compromised resulting from either construction damage or as a result of a temporary obstruction appropriate warning signs (in accordance with AS1742.3) shall be erected. Should a continuous path not be able to be maintained, an 'approved' temporary pedestrian facility suitable for all path users shall be put in place. If there is a request to erect scaffolding, site fencing etc. or if building materials are required to be stored within the road reserve, once a formal request has been received, the matter will be assessed by the City and if considered appropriate a permit shall be issued if the proposed encroachment into the road reserve is deemed to be inappropriate.
- 11. Any additional property numbering to the abovementioned address which results from this application will be allocated by the City of Vincent. The applicant is requested to liaise with the City in this regard during the building permit process.
- 12. A Demolition Permit shall be obtained from the City prior to commencement of any demolition works on the site.
- 13. The applicant and owner are advised that sufficient parking can be provided on the subject site and as such the City of Vincent will not issue a residential or visitor car parking permit to any owner or occupier of the residential dwellings. This information should be provided to all prospective purchasers and it is recommended that a notice be placed on Sales Contracts to advise purchasers of this restriction.

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